MOUNTAIN VIEW ESTATES SUBDIVISION PHASE 2 CITY COUNCIL MEETING APRIL 5, 2018 FINAL PLAT ~500 SOUTH & HAMMER ROAD

ZONING- R-2 Allows Residential. Lots are all at least 12,000 sq. feet with 100 feet of frontage.

UTILITIES- Currently stubbed to this phase. A 10-inch culinary line will be installed in Hammer Road. This will loop back to 300 South.

CURB AND SIDEWALKS- A ribbon curb will be installed on all streets with sidewalks running in front of all homes.

ROADS- Sixty-eight-foot ROW on main roads and sixty-foot ROW on secondary streets.

STORM WATER- They will be installing swales in the planting strips.


FENCING- All homes will have a fenced backyard.

NOTES-

All construction drawings have been approved by the City Engineer.

MOUNTAIN VIEW ESTATES, PHASE 2 FINAL PLAT

LOCATED IN THE SOUTH HALF OF THE NORTHEAST QUARTER OF SECTION 10, TOWNSHIP 10 NORTH, RANGE 1 EAST OF THE SALT LAKE BASE AND MERIDIAN HYRUM CITY, CACHE COUNTY, UTAH MARCH 2018

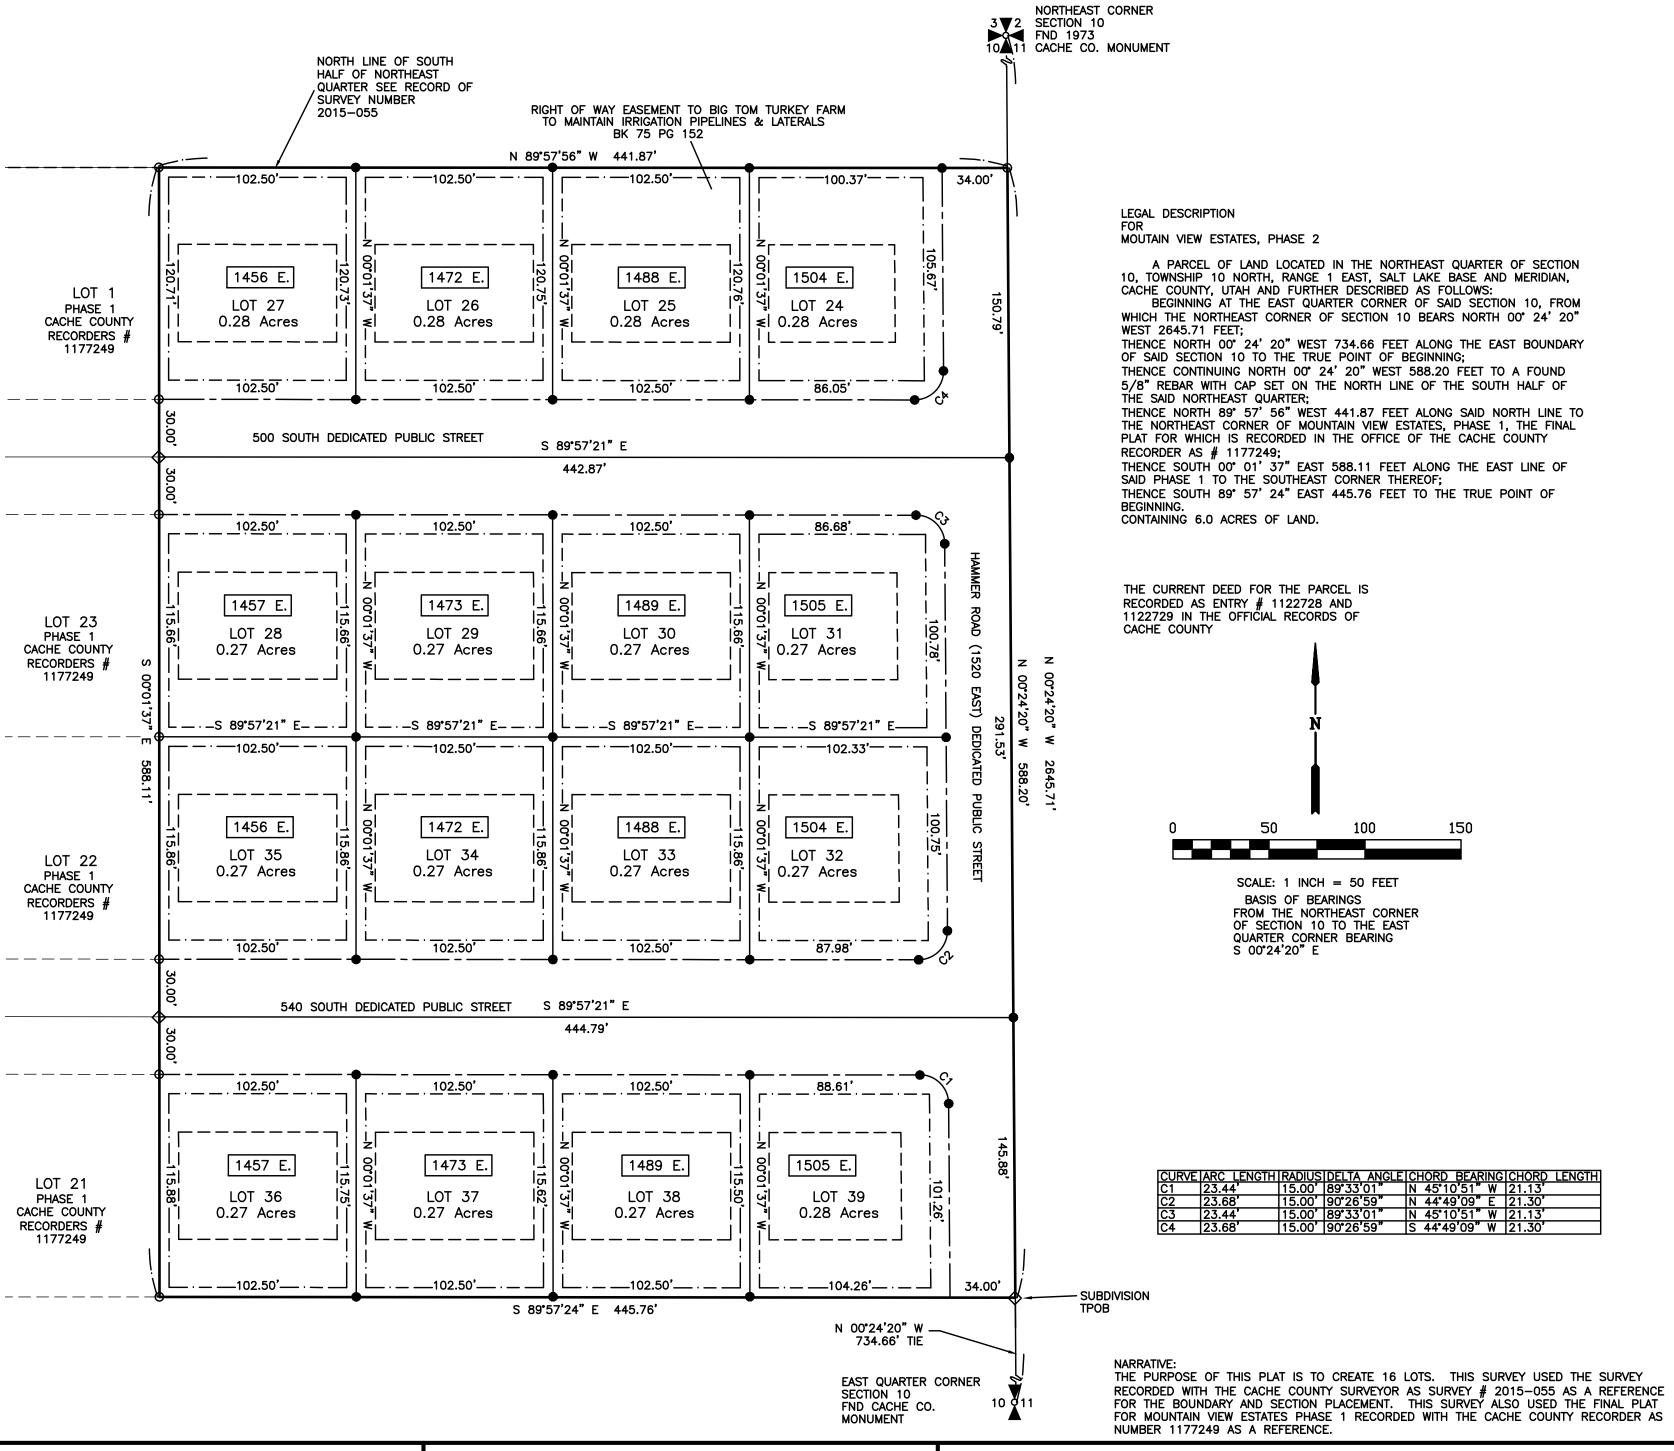

SURVEYOR'S CERTIFICATE

, TIMOTHY LYNN CHRISTENSEN, A LICENSED LAND SURVEYOR IN THE STATE OF UTAH, DO HEREBY CERTIFY THAT A SURVEY WAS MADE UNDER MY DIRECTION OF THE PROPERTY DESCRIBED IN THIS BOUNDARY DESCRIPTION AND THAT THE PLAT UPON WHICH THIS CERTIFICATE APPEARS WAS MADE UNDER MY DIRECTION, THAT SAID PLAT SHOWS THE WHOLE OF THE DESCRIBED LAND WHICH IS KNOWN AS MOUNTAIN VIEW ESTATES, PHASE 2 IN CACHE COUNTY, UTAH; THAT SAID PLAT CORRECTLY REPRESENTS THE LOTS AS SURVEYED ON THE GROUND, AND THE PERTINENT PROVISIONS OF THE STATUTES OF THE STATE OF UTAH HAVE BEEN COMPLIED WITH. I FURTHER CERTIFY THIS IS A TRUE COPY OF SAID PLAT.

TIMOTHY LYNN CHRISTENSEN

OWNER'S DEDICATION

KNOW ALL MEN BY THESE PRESENTS THAT WE THE UNDERSIGNED, ARE THE OWNERS OF THE ABOVE DESCRIBED TRACT OF LAND, HAVING CAUSED THE SAME TO BE SUBDIVIDED INTO LOTS AND STREETS, TO BE HEREINAFTER KNOWN AS MOUNTAIN VIEW ESTATES PHASE 2. WE HEREBY DEDICATE FOR PUBLIC USE. AND DO WARRANT. DEFEND AND SAVE THE CITY OF HYRUM HARMLESS AGAINST ANY EASEMENTS OR OTHER ENCUMBRANCES ON THE DEDICATED STREETS WHICH WILL INTERFERE WITH THE MUNICIPALITY'S USE. OPERATION AND MAINTENANCE OF THE STREETS AND DO FURTHER DEDICATE THE EASEMENTS AS SHOWN WITH THE SAME WARRANTY AS GIVEN FOR THE OTHER DEDICATED PROPERTY.

IN WITNESS WE HAVE HEREUNTO SET OUR SIGNATURES THIS _____ DAY OF

KIM DATWYLER, EXECUTIVE DIRECTOR TROY KARTCHNER, MANAGING MEMBER NEIGHBORHOOD NON-PROFIT HOUSE CORP. ELK MOUNTAIN, LLC

CORPORATE ACKNOWLEDGEMENT

STATE OF UTAH COUNTY OF CACHE

ON THIS _____ DAY OF _____ 2018, PERSONALLY APPEARED BEFORE ME, KIM DATWYLER, WHOSE IDENTITY IS PERSONALLY KNOWN TO ME (OR PROVEN ON THE BASIS OF SATISFACTORY EVIDENCE) AND WHO BY ME DULY SWORN/AFFIRMED, DID SAY THAT SHE IS THE EXECUTIVE DIRECTOR OF NEIGHBORHOOD NON-PROFIT HOUSING CORPORATION AND SAID DOCUMENT WAS SIGNED BY HER IN BEHALF OF SAID CORPORATION BY AUTHORITY OF ITS BYLAWS, OR (RESOULTION OF ITS BOARD OF DIRECTORS), AND SAID KIM DATWYLER ACKNOWLEDGED TO ME THAT SAID CORPORATION EXECUTED THE

IN WITNESS WHEREOF, I HAVE HEREUNTO SET MY HAND AND AFFIXED MY SEAL THE DAY AND YEAR FIRST ABOVE WRITTEN.

> NOTARY PUBLIC FOR ____ RESIDING AT: _____ MY COMMISSION EXPIRES: _____

ACKNOWLEDGEMENT BY LIMITED LIABILITY COMPANY

STATE OF _____ COUNTY OF _____

UNDERSIGNED NOTARY PUBLIC, PERSONALLY APPEARED TROY KARTCHNER, KNOWN OR IDENTIFIED TO ME TO BE THE MANAGING MEMBER OF ELK
MOUNTAIN, LLC, THE OWNER OF THE ABOVE DESCRIBED SUBDIVISION AND THE PERSON WHO EXECUTED THE INSTRUMENT ON BEHALF OF SAID LIMITED LIABILITY COMPANY, AND ACKNOWLEDGED TO ME THAT SUCH LIMITED LIABILITY COMPANY EXECUTED THE SAME.

IN WITNESS WHEREOF, I HAVE HEREUNTO SET MY HAND AND AFFIXED MY SEAL THE DAY AND YEAR FIRST ABOVE WRITTEN.

> NOTARY PUBLIC FOR _____ MY COMMISSION EXPIRES: _

COMCAST CABLE DATE	
CENTURYLINK COMMUNICATIONS DATE	

GENERAL NOTES:

3. LOTS: 16 LOTS

2. TOTAL PHASE 2 AREA: 6.0 ACRES. LOT AREA: 4.4 ACRES

DEDICATED ROAD AREA: 1.6 ACRES

FT. ON THE SIDES AND BACK.

1. CURRENT ZONE: R-2, RESIDENTIAL MULTI FAMILY.

4. NO STRUCTURES MAY BE BUILT WITHIN ANY

PUBLIC UTILITY EASEMENT. PUBLIC UTILITY EASEMENTS ARE 10.0 FT. ON THE FRONT AND 5.0

5. ALL EXPENSES INVOLVING THE NECESSARY IMPROVEMENTS OR EXTENSIONS FOR A CULINARY

CABLE TELEVISION SERVICE, GRADING AND LANDSCAPING, STORM DRAINAGE SIGNAGE, STREET

SHALL BE PAID FOR BY THE DEVELOPER.

WATER SYSTEM, SANITARY SEWER SYSTEM, GAS SERVICE, ELECTRICAL SERVICE, TELEPHONE SERVICE,

LIGHTING, CURBS AND GUTTERS, FIRE HYDRANTS. PAVEMENT, SIDEWALKS AND OTHER IMPROVEMENTS

6. SET BACKS SHOWN REFLECT CITY CODE AS OF

DATE PLAT RECORDED. ALL BUILDINGS SHALL BE

SUBJECT TO SETBACKS REQUIRED BY CITY CODES IN

EFFECT WHEN PERMITS ARE ISSUED. ON THIS PLAT

SIDES OR 25' ON SIDE IF SIDE IS ON A ROADWAY.

7. THIS PROPERTY IS LOCATED IN THE VICINITY OF

PURPOSES. IT MAY BE ANTICIPATED THAT SUCH

AGRICULTURAL USES AND ACTIVITIES MAY OR MAY

NOT IN THE FUTURE BE CONDUCTED IN THIS AREA

SOUND AGRICULTURAL PRACTICES AND NOT BEAR A

DIRECT THREAT TO THE PUBLIC HEALTH AND SAFETY.

THERE IS AN EXISTING RIGHT OF WAY EASEMENT

TO BIG TOM TURKEY FARM TO MAINTAIN IRRIGATION

FOR LOTS 24 THROUGH 27 IS 40.00 TO AVOID

AND ALL OTHER ASPECTS ASSOCIATED WITH AN

AGRICULTURAL LIFESTYLE. FUTURE RESIDENTS

IRRIGATION LINE.

PIPELINES AND LATERALS ALONG THE NORTH LINE OF LOTS 1 THROUGH 6. THE REAR BUILDING SETBACK

HOME CONSTRUCTION CONFLICTING WITH THE BURIED

9. THIS AREA IS SUBJECT TO THE NORMAL EVERYDAY SOUNDS, ODORS, SIGHTS, EQUIPMENT, FACILITIES,

SHOULD ALSO RECOGNIZE THE RISKS INHERENT WITH

LEGEND

DEED (RECORD) LINE

SECTION CORNER FOUND

PROPERTY CORNER REPORTED TO BE SET SET BY THIS SURVEY 5/8" REBAR W/ CAP POINT NOT FOUND OR SET

PUBLIC UTILITY EASEMENT SEE NOTE 4 ABOVE

BUILDING SETBACKS

SEE NOTE 6 ABOVE

SUBDIVISION BOUNDARY

LOT LINES

BASIS OF BEARINGS

FROM THE NORTHEAST CORNER OF SECTION 10 TO THE EAST QUARTER CORNER BEARING S 00°24'20" E 2645.71 FEET

ADDRESS

— x — EXISTING FENCE

AND SUCH USES ARE PREVIOUSLY EXISTING USES.

AGRICULTURAL USES AND SITUATIONS MUST BE

THE SETBACK IS 40' ALONG NORTH SIDE OF

SUBDIVISION DUE TO IRRIGATION EASEMENT.

PROPERTY THAT IS USED FOR AGRICULTURAL

THEY ARE 30' ON FRONT, 30' ON BACK AND 10' ON

PRESENTED TO THE HYRUM CITY CULINARY WATER DEPARTMENT THIS__ OF_____A.D. 2018, AT WHICH TIME THIS SUBDIVISION WAS APPROVED AND ACCEPTED.

AND ACCEPTANCE

HYRUM CITY SANITARY SEWER APPROVAL

HYRUM CITY CULINARY WATER APPROVAL

PRESENTED TO THE HYRUM CITY SANITARY SEWER DEPARTMENT THIS_____DAY OF_____A.D. 2018, AT WHICH TIME THIS SUBDIVISION WAS APPROVED

MOUNTAIN
SECTION 10, T.

ASSOCIATES
132 SOUTH STATE
PRESTON, IDAHO 83263



UTILITY COMPANIES APPROVAL APPROVAL AS TO FORM

APPROVED AS TO FORM THIS______DAY OF_____A.D. 2018

COUNTY SURVEYOR'S CERTIFICATE

I CERTIFY THAT I HAVE EXAMINED THIS PLAT AND FIND IT TO BE CORRECT

AND IN ACCORDANCE WITH THE INFORMATION ON FILE IN THIS OFFICE AND

FURTHER CERTIFY THAT IT MEETS THE MINIMUM STANDARDS FOR PLATS

COUNTY SURVEYOR

CITY ATTORNEY

REQUIRED BY COUNTY ORDINANCE AND STATE

ENGINEER'S CERTIFICATE

I CERTIFY THAT I HAVE EXAMINED THIS PLAT AND FIND IT TO BE CORRECT

AND IN ACCORDANCE WITH THE INFORMATION ON FILE IN THIS OFFICE AND

CITY ENGINEER

COUNTY RECORDER'S NO._____

COUNTY RECORDER

STATE OF UTAH, COUNTY OF CACHE, RECORDED AND FILED AT THE

THE CITY ORDINANCE.

FILED IN: FILE OF PLATS

DATE

.REQUEST_

THE UTILITY EASEMENTS SHOWN ON THIS PLAT ARE APPROVED. QUESTAR GAS _____

DATE_____ HYRUM CITY POWER ______

PLANNING COMMISSION CHAIRMAN APPROVAL AND ACCEPTANCE

PRESENTED TO THE HYRUM CITY PLANNING COMMISSION CHAIRMAN THIS_____DAY OF_______A.D. 2018, AS THIS WAS RECOMMENDED TO THE CITY COUNCIL FOR APPROVAL. MAYOR'S APPROVAL AND ACCEPTANCE

PRESENTED TO THE HYRUM CITY COUNCIL THIS _____ DAY OF_____A.D. 2018, AS THIS WAS APPROVED AND ACCEPTED.


MAYOR

AND ACCEPTANCE

MOUNTAIN VIEW ESTATES PHASE 2 CONSTRUCTION DOCUMENTS

March 29, 2018

VICINITY MAP:

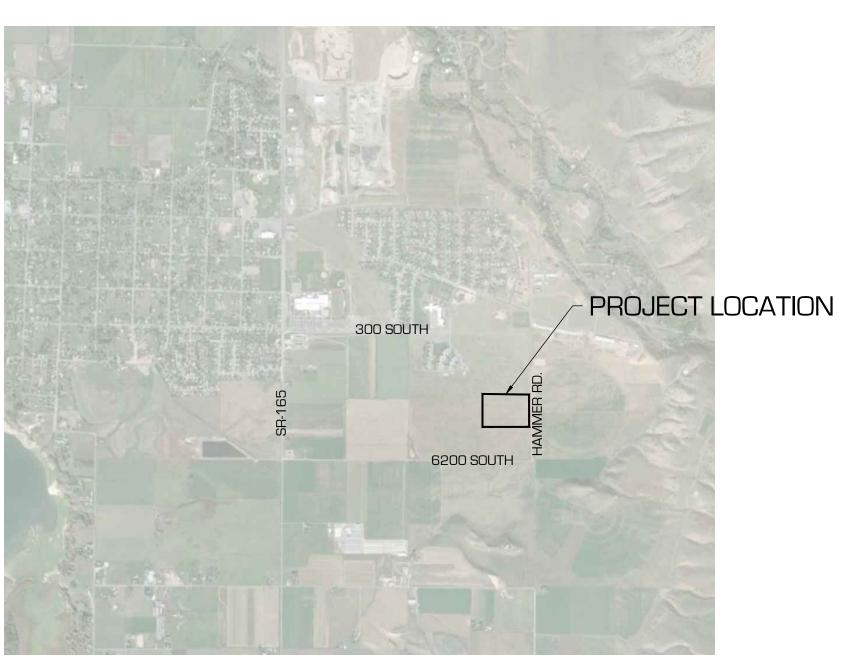

Sheet List Table						
SHEET DESCRIPTION	SHEET NUMBER					
INDEX	C-001					
LEGEND	C-002					
REFERENCE SHEET	C-003					
STORMDRAIN & EROSION CONTROL	C-201					
SITE/UTILITY PLAN & PROFILE	C-301					
SITE/UTILITY PLAN & PROFILE	C-302					
SITE/UTILITY PLAN & PROFILE	C-303					
STANDARD DETAILS	C-501					
STANDARD DETAILS	C-502					

GENERAL NOTES:

1. APPROVAL OF THESE PLANS BY THE CITY ENGINEER DOES NOT AUTHORIZE ANY WORK TO BE PERFORMED UNTIL A NOTICE TO PROCEED HAS BEEN ISSUED.

- 2. THE APPROVAL OF THIS PLAN OR ISSUANCE OF A PERMIT BY HYRUM CITY DOES NOT AUTHORIZE THE SUBDIVIDER AND OWNER TO VIOLATE ANY FEDERAL, STATE OR CITY LAWS, ORDINANCES, REGULATIONS, OR POLICIES.
- 3. THE CONTRACTOR SHALL BE RESPONSIBLE FOR SURVEY MONUMENTS AND/OR VERTICAL CONTROL BENCHMARKS WHICH ARE DISTURBED OR DESTROYED BY CONSTRUCTION. A SURVEY CREW MUST FIELD LOCATE, REFERENCE, AND/OR PRESERVE ALL HISTORICAL OR VERTICAL CONTROLLING MONUMENTS PRIOR TO ANY EARTHWORK. IF DESTROYED, A SURVEY CREW SHALL REPLACE SUCH MONUMENTS WITH APPROPRIATE VERTICAL CONTROLLING MONUMENTS. THE CONTRACTOR WILL BE RESPONSIBLE FOR THE COST OF REPLACING ANY VERTICAL CONTROL BENCHMARKS DESTROYED BY THE CONSTRUCTION.
- 4. CONTRACTOR SHALL IMPLEMENT AN EROSION AND SEDIMENT CONTROL PROGRAM DURING THE PROJECT GRADING AND/OR CONSTRUCTION ACTIVITIES. THE PROGRAM SHALL MEET ALL APPLICABLE REQUIREMENTS OF THE STATE OF UTAH AND HYRUM CITY.
- 5. "PUBLIC IMPROVEMENT SUBJECT TO DESUETUDE OR DAMAGE." IF REPAIR OR REPLACEMENT OF SUCH PUBLIC IMPROVEMENTS IS REQUIRED, THE OWNER SHALL OBTAIN THE REQUIRED PERMITS FOR WORK IN THE PUBLIC RIGHT-OF-WAY, SATISFACTORY TO THE PERMIT- ISSUING AUTHORITY.
- 6. ALL EXISTING AND/OR PROPOSED PUBLIC UTILITY SYSTEM AND SERVICE FACILITIES SHALL BE INSTALLED UNDERGROUND IN ACCORDANCE WITH HYRUM CITY STANDARDS AND SPECIFICATIONS.
- 7. PRIOR TO ANY DISTURBANCE TO THE SITE, EXCLUDING UTILITY MARK-OUTS AND SURVEYING, THE CONTRACTOR SHALL MAKE ARRANGEMENTS FOR A PRE-CONSTRUCTION MEETING WITH THE CITY OF HYRUM.
- 8. DEVIATIONS FROM THESE SIGNED PLANS WILL NOT BE ALLOWED UNLESS A CONSTRUCTION CHANGE IS APPROVED BY THE CITY ENGINEER OR THE CHANGE IS REQUIRED BY THE CITY INSPECTOR.
- 9. DEVELOPER SHALL SATISFY THE SECURITY OF PERFORMANCE REQUIREMENTS PER HYRUM CITY CODE SECTION 16.20.030.
- 10. THIS DESIGN CONFORMS TO R309-550, TRANSMISSION AND DISTRIBUTION PIPELINES, UTAH DIVISION OF ADMINISTRATIVE RULES.
- 11. ALL MATERIALS WHICH MAY CONTACT DRINKING WATER, INCLUDING PIPES, GASKETS, LUBRICANTS AND O-RINGS, SHALL BE ANSI-CERTIFIED AS MEETING THE REQUIREMENTS OF NSF STANDARD 61, DRINKING WATER SYSTEM COMPONENTS HEALTH EFFECTS. TO PERMIT FIELD VERIFICATION OF THIS CERTIFICATION, ALL SUCH COMPONENTS SHALL BE APPROPRIATELY STAMPED WITH THE NSF LOGO.

STANDARD SPECIFICATIONS:

- 1. HYRUM CITY SPECIFICATIONS.
- 2. STORM WATER SPECIFICATIONS ARE PER THE EPA NATIONAL MENU OF STORMWATER BEST MANAGEMENT PRACTICES UNDER THE NATIONAL POLLUTANT DISCHARGE ELIMINATION SYSTEM (NPDES) AND THE UTAH DEPARTMENT OF WATER QUALITY STORMWATER MANAGMENT PROGRAM.
- 3. THE SPECIFICATIONS MENTIONED IN ITEMS ONE AND TWO SHALL SUPERSEDE ANY CONFLICTING SPECIFICATIONS CONTAINED WITHIN THESE PLANS.
- 4. DESIGN OF THE CULINARY WATER SYSTEM IMPROVEMENTS MEETS ALL APPLICABLE RULES, STANDARDS & REGULATIONS PER UAC B309-500

STANDARD DRAWINGS:

1. HYRUM CITY STANDARD DRAWINGS.

SUBMITTALS:

ORIGINAL SUBMITTAL MARCH 19, 2018
RE-SUBMITTAL MARCH 29, 2018

GENERAL NOTES:

- CURRENT ZONE: R-2, RESIDENTIAL MULTI FAMILY
- SETBACKS: PER CITY CODE
- ALL EXPENSES INVOLVING THE NECESSARY
 IMPROVEMENTS OR EXTENSIONS FOR A CULINARY WATER
 SYSTEM, SANITARY SEWER SYSTEM, GAS SERVICE,
 ELECTRICAL SERVICE, TELEPHONE SERVICE, CABLE
 TELEVISION SERVICE, GRADING AND LANDSCAPING, STORM
 DRAINAGE SIGNAGE, STREET LIGHTING AND OTHER
 IMPROVEMENTS SHALL BE PAID FOR BY THE DEVELOPER.


PROJECT CONTACTS:

- PROPERTY OWNER & DEVELOPER:
 NEIGHBORHOOD HOUSING SOLUTIONS
 KIM DATWYLER, PROJECT MANAGER
 195 GOLF COURSE ROAD
 LOGAN, UT 84321
 E: KIM@NNHC.NET
- CIVIL ENGINEER:
 CIVIL SOLUTIONS GROUP
 MICHAEL E. TAYLOR
 540 WEST GOLF COURSE ROAD SUITE B1
 PROVIDENCE, UT 84332
 P: 435.213.3762
 E: MTAYLOR@CSG.WORK
- LAND SURVEYOR
 AA HUDSON AND ASSOCIATES
 TIM CHRISTENSEN
 132 S STATE STREET
 PRESTON, ID 83263
 P: 208.221.4144
 E:TIM@AAHUDSON.COM
- LANDSCAPE ARCHITECT
 CIVIL SOLUTIONS GROUP
 KENI ALTHOUSE
 540 WEST GOLF COURSE ROAD SUITE B1
 PROVIDENCE, UT 84332
 E: KALTHOUSE@CSG.WORK
- HYRUM CITY MANAGER
 RON SALVESON
 60 WEST MAIN
 HYRUM CITY, UT 84319
- HYRUM CITY MANAGER
 AQUA ENGINEERING
 533 WEST 2600 SOUTH
 BOUNTIFUL, UT
- ROCKY MOUNTAIN POWER JAMES KNIGHT 435.563.2921
- UTAH STORMWATER PERMIT
 UTAH DEPARTMENT OR WATER QUALITY
 P.O. BOX 144870
 SALT LAKE CITY, UTAH 84114-4870
 P. 801.538.6146
 http://www.waterquality.utah.gov/UPDES/stormwater.htm
- QUESTAR GAS:
 KRISTI FIEDEL
 895 WEST 800 NORTI
 LOGAN, UTAH 84321
 P. 435.752.7751



TION DOCUMENTS

PHASE 2
CONSTRUCTION I
6200 SOUTH 800 EAST

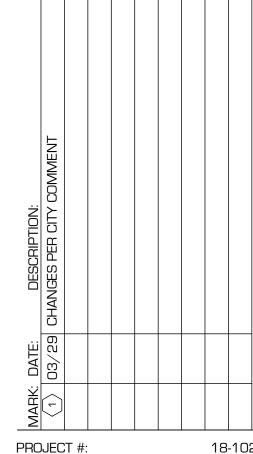

PROJECT #: 18-102

DRAWN BY: C. BOWN

PROJECT MANAGER: M. TAYLOR

ISSUED: 03.29.18

DESIGNED BY:

M. TALYOR



INDEX

C-001



MOUNTAIN VIEW ESTATES PHASE 2 CONSTRUCTION DOCUMENTS

March 29, 2018

LEGEND PROPOSED LEGEND EXISTING 30" PROPOSED CURB AND GUTTER. — — — — — BUILDING SETBACK EXISTING CURB AND GUTTER

EXISTING TO BE REMOVED

	LEGEND EXISTING		LEGEND PROPOSED
₩V	EXISTING WATER VALVE	wv	
Ç,	EXISTING FIRE HYDRANT		PROPOSED WATER VALVE
>Y∨ 		IRV	PROPOSED IRRIGATION VALVE
	EXISTING STORM DRAIN BOX	%	PROPOSED FIRE HYDRANT
S	EXISTING SEWER MANHOLE	(S)	PROPOSED 4' SEWER MANHOLE
	EXISTING STORM DRAIN MANHOLE		PROPOSED WATER METER
		\otimes	THO COLD WATER WELL

EXISTING WATER METER



THESE PLANS AND SPECIFICATIONS ARE THE PROPERTY OF CIVIL SOLUTIONS GROUP, INC, AN SHALL NOT BE PHOTOCOPIED, RE-DRAWN, OR USED ON ANY OTHER PROJECT OTHER THAN THE PROJECT SPECIFICALLY DESIGNED FOR, WITHOUT WRITTEN PERMISSION. THE OWNERS AND ENGINEERS OF CIVIL SOLUTIONS GROUP, INC. DISCLAIM ANY LIABILITY FOR ANY CHANGES OR MODIFICATIONS MADE TO THESE PLANS OR THE DESIGN THEREON WITHOUT THEIR CONSENT. THESE PLANS ARE DRAWN TO SCALE WHEN PLOTTED ON A 24" X 36" SHEET OF

PROJECT #: C. BOWN DRAWN BY: PROJECT MANAGER: M. TAYLOR M. TALYOR DESIGNED BY: ISSUED: 03.29.18


solutionsgrouping




LEGEND



MOUNTAIN VIEW ESTATES PHASE 2 CROSS REFERENCE SHEET

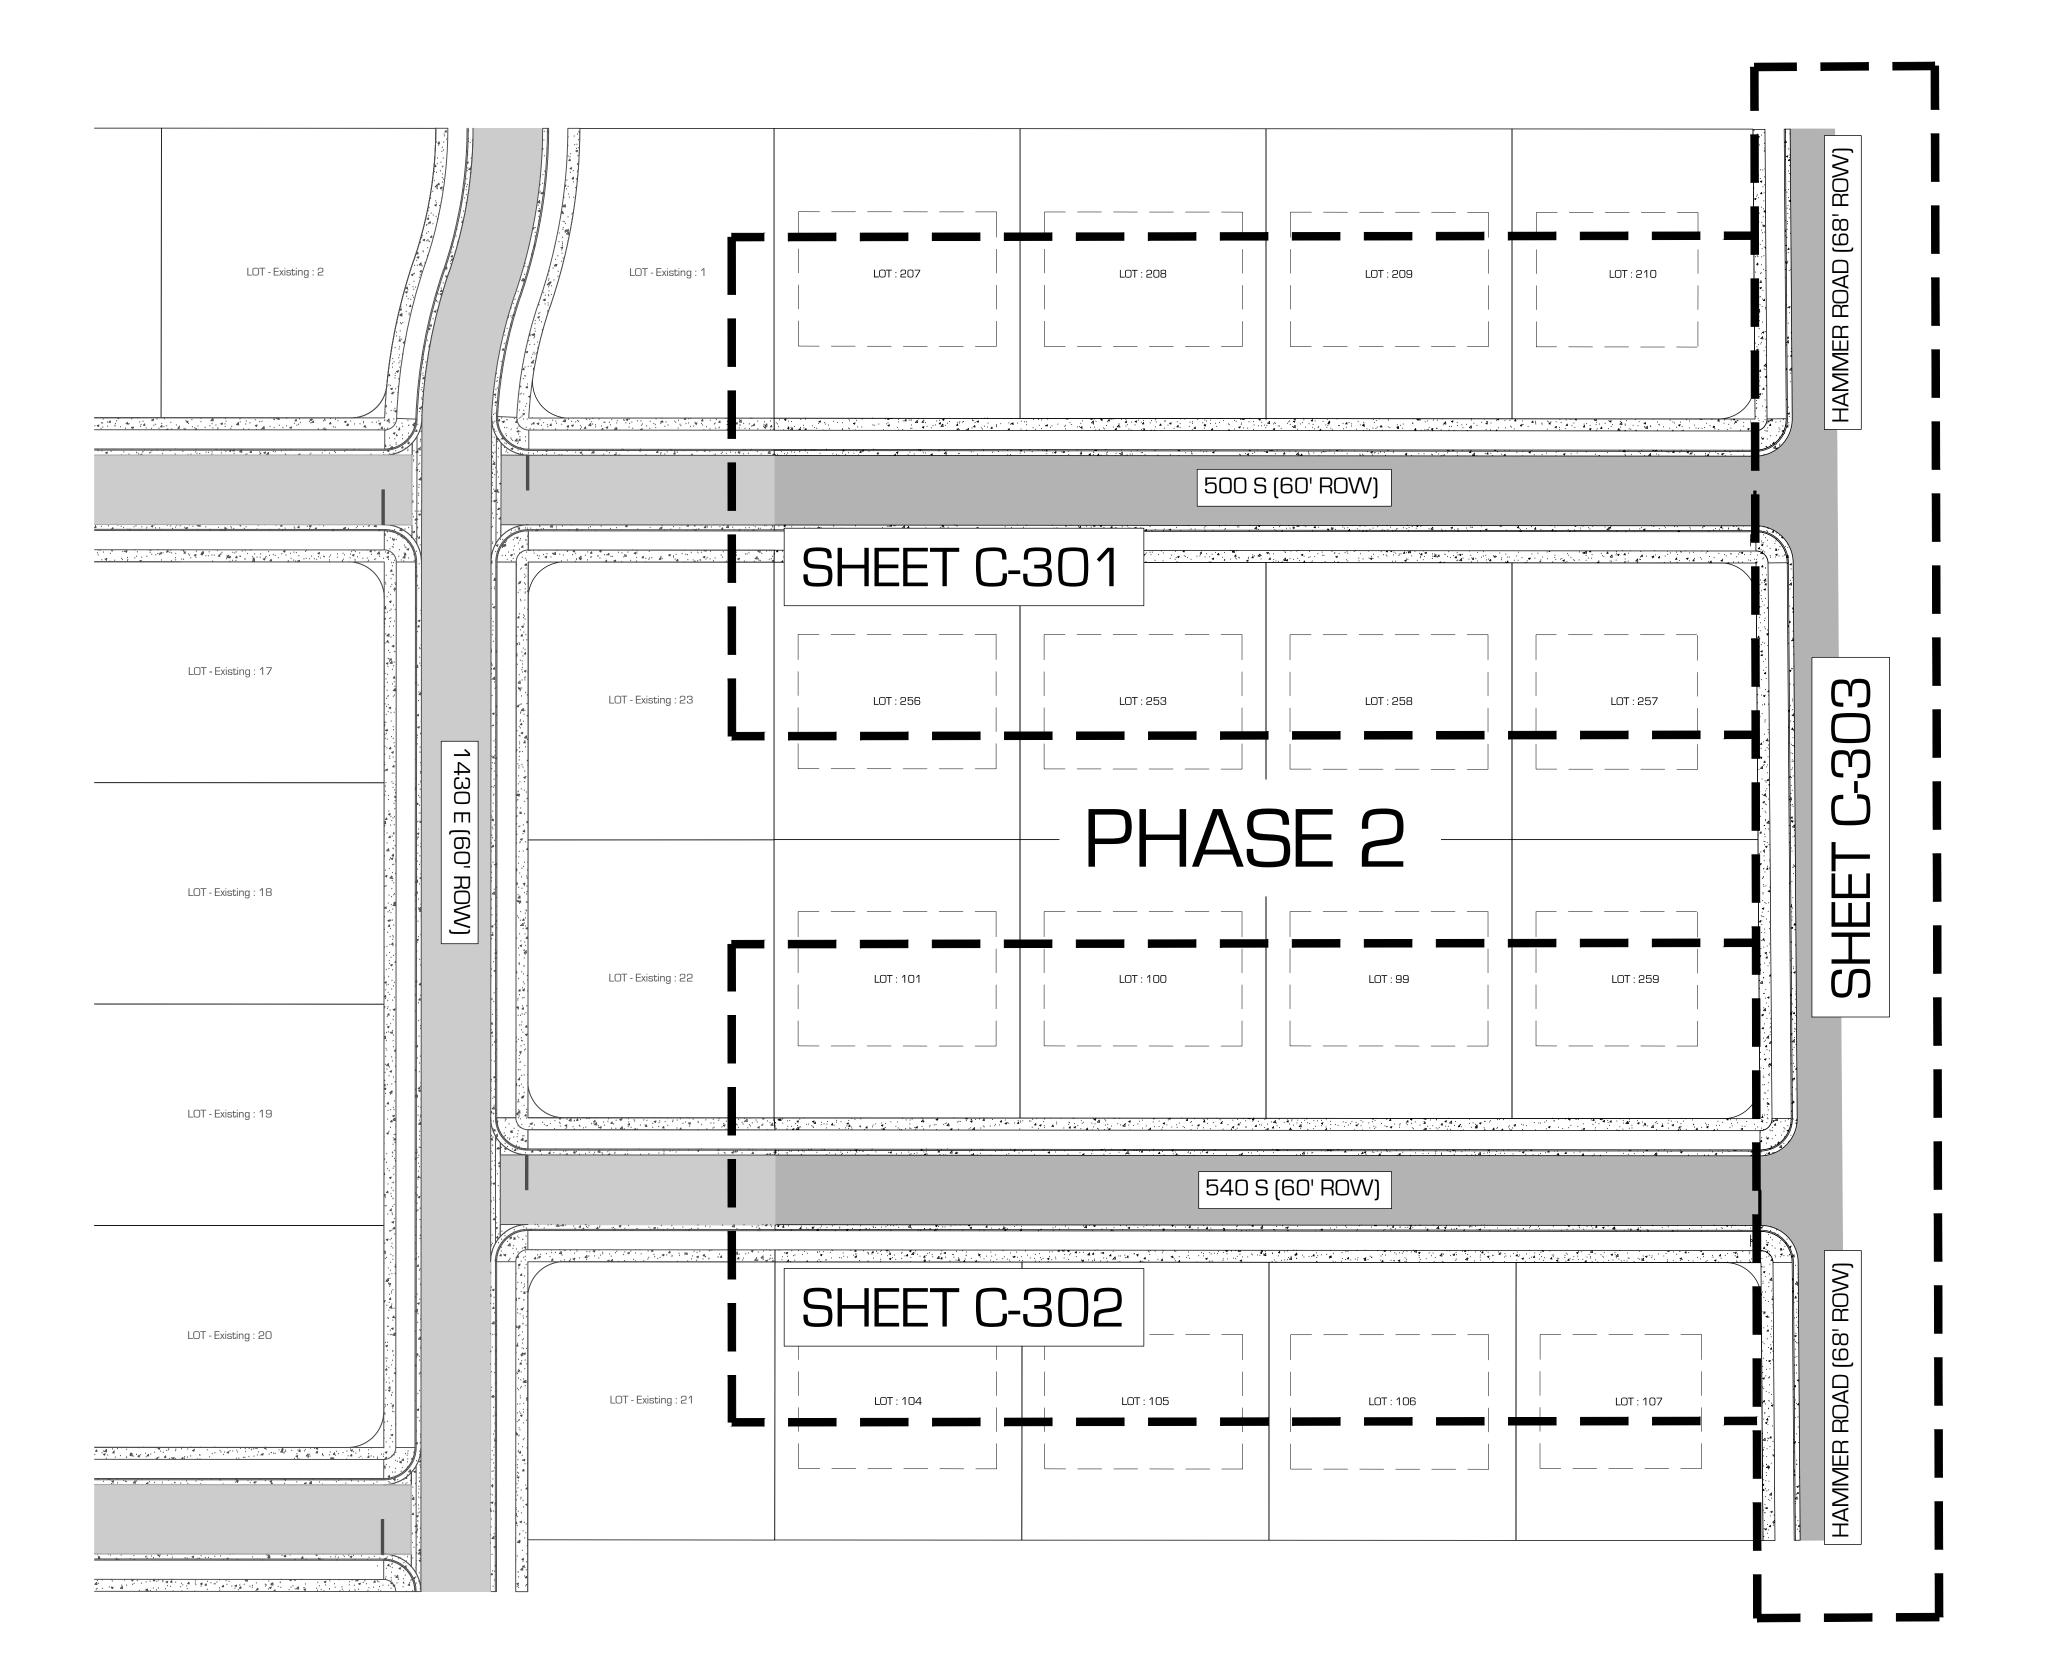

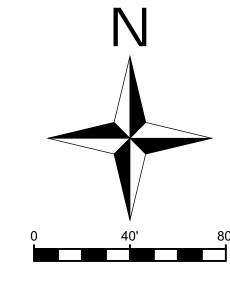



Sgrouping


solution

MOUNTAIN VIEW ESTATES

PHASE 2

CONSTRUCTION DOCUMEN

6200 SOUTH 800 EAST

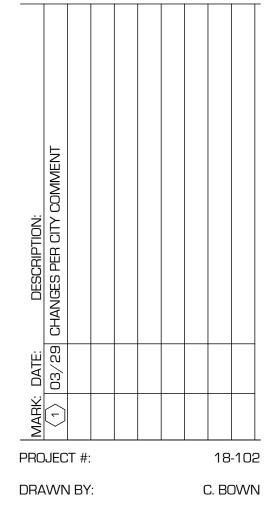

PROJECT #: 18-102

DRAWN BY: C. BOWN

PROJECT MANAGER: M. TAYLOR

DESIGNED BY: M. TALYOR

ISSUED: 03.29.18




REFERENCE SHEET

C-003




THESE PLANS AND SPECIFICATIONS ARE THE PROPERTY OF CIVIL SOLUTIONS GROUP, INC, AN SHALL NOT BE PHOTOCOPIED, RE-DRAWN, OR USED ON ANY OTHER PROJECT OTHER THAN THE PROJECT SPECIFICALLY DESIGNED FOR, WITHOUT WRITTEN PERMISSION. THE OWNERS AND ENGINEERS OF CIVIL SOLUTIONS GROUP, INC. DISCLAIM ANY LIABILITY FOR ANY CHANGES OR MODIFICATIONS MADE TO THESE PLANS OR THE DESIGN THEREON WITHOUT THEIR CONSENT. THESE PLANS ARE DRAWN TO SCALE WHEN PLOTTED ON A 24" X 36" SHEET OF PAPER.

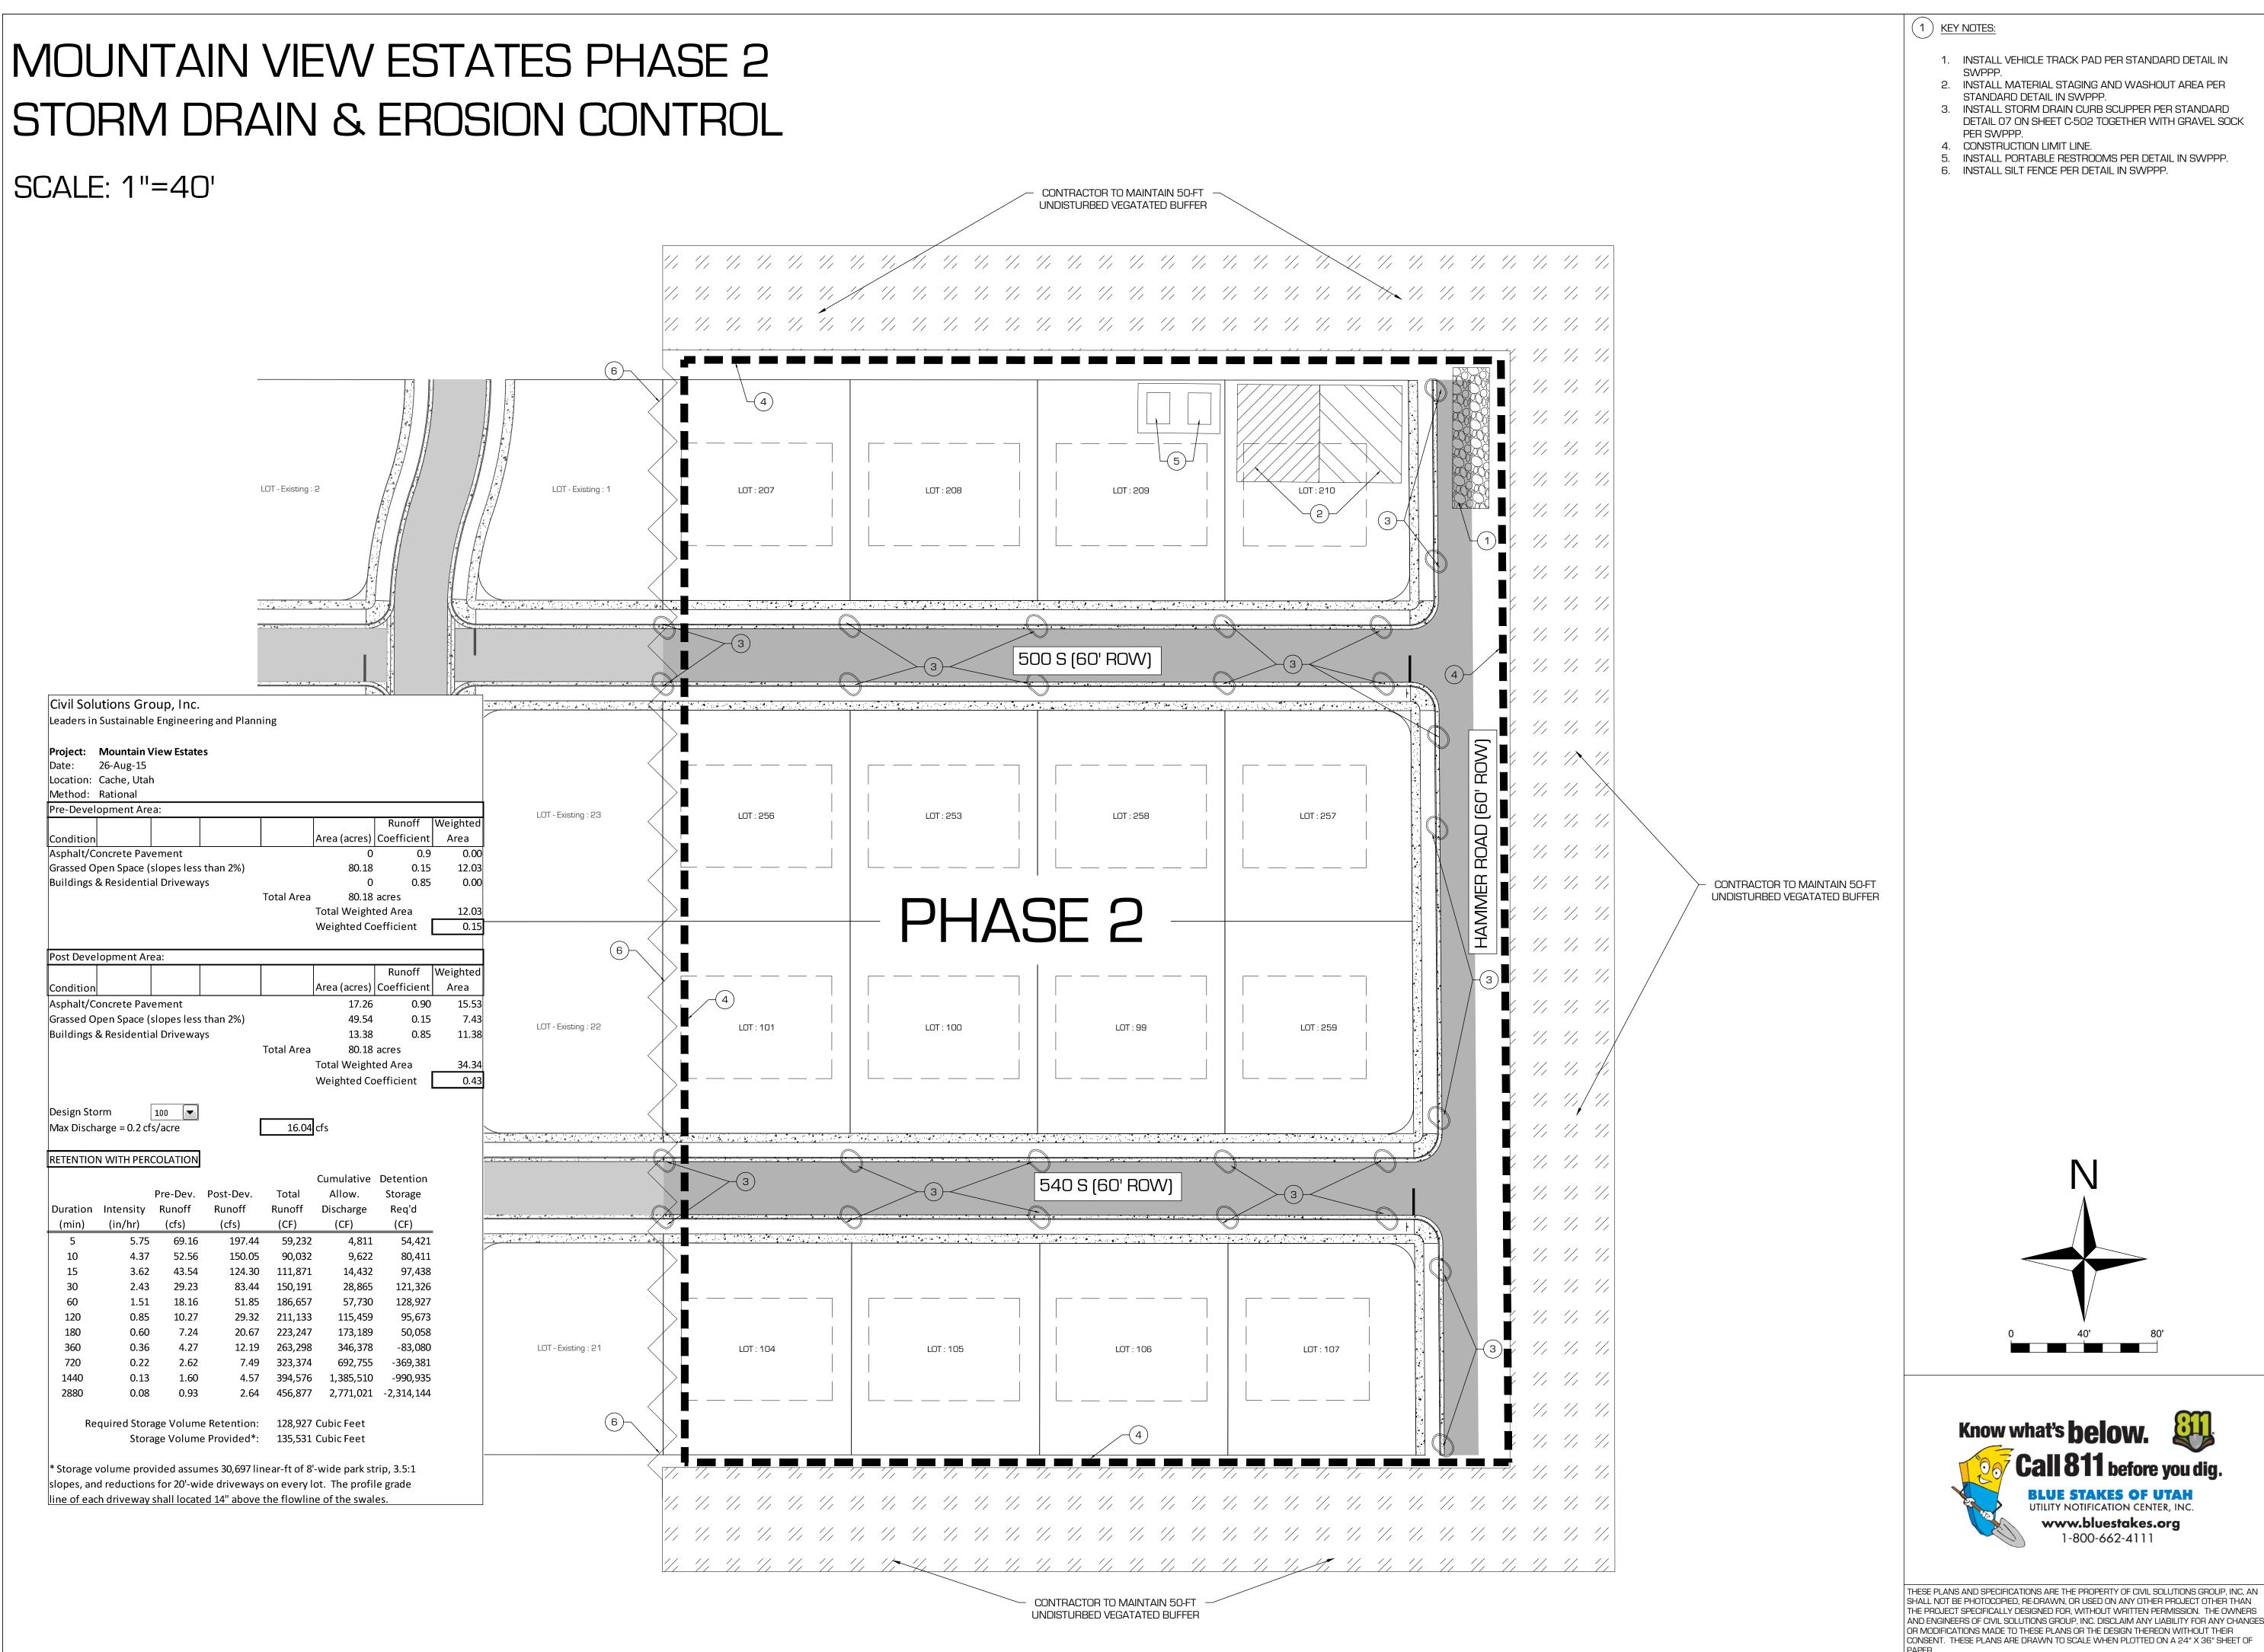

(1) KEY NOTES:

- 2. INSTALL MATERIAL STAGING AND WASHOUT AREA PER
- STANDARD DETAIL IN SWPPP. 3. INSTALL STORM DRAIN CURB SCUPPER PER STANDARD DETAIL 07 ON SHEET C-502 TOGETHER WITH GRAVEL SOCK
- 4. CONSTRUCTION LIMIT LINE.
- INSTALL PORTABLE RESTROOMS PER DETAIL IN SWPPP.
- 6. INSTALL SILT FENCE PER DETAIL IN SWPPP.

OUDING 5 solutio

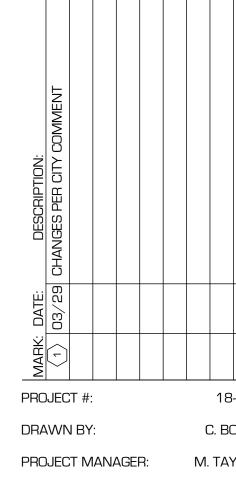

C. BOWN M. TAYLOR DESIGNED BY: M. TALYOR ISSUED: 03.29.18

No. 8243188-2202

Call 811 before you dig.

BLUE STAKES OF UTAH

UTILITY NOTIFICATION CENTER, INC. www.bluestakes.org


STORMDRAIN & **EROSION** CONTROL


C-201

- LEADERS IN SUSTAINABLE ENGINEERING AND PLANNING -

MOUNTAIN VIEW ESTATES PHASE 2 SITE/UTILITY PLAN & PROFILE

SCALE: 1"=20'

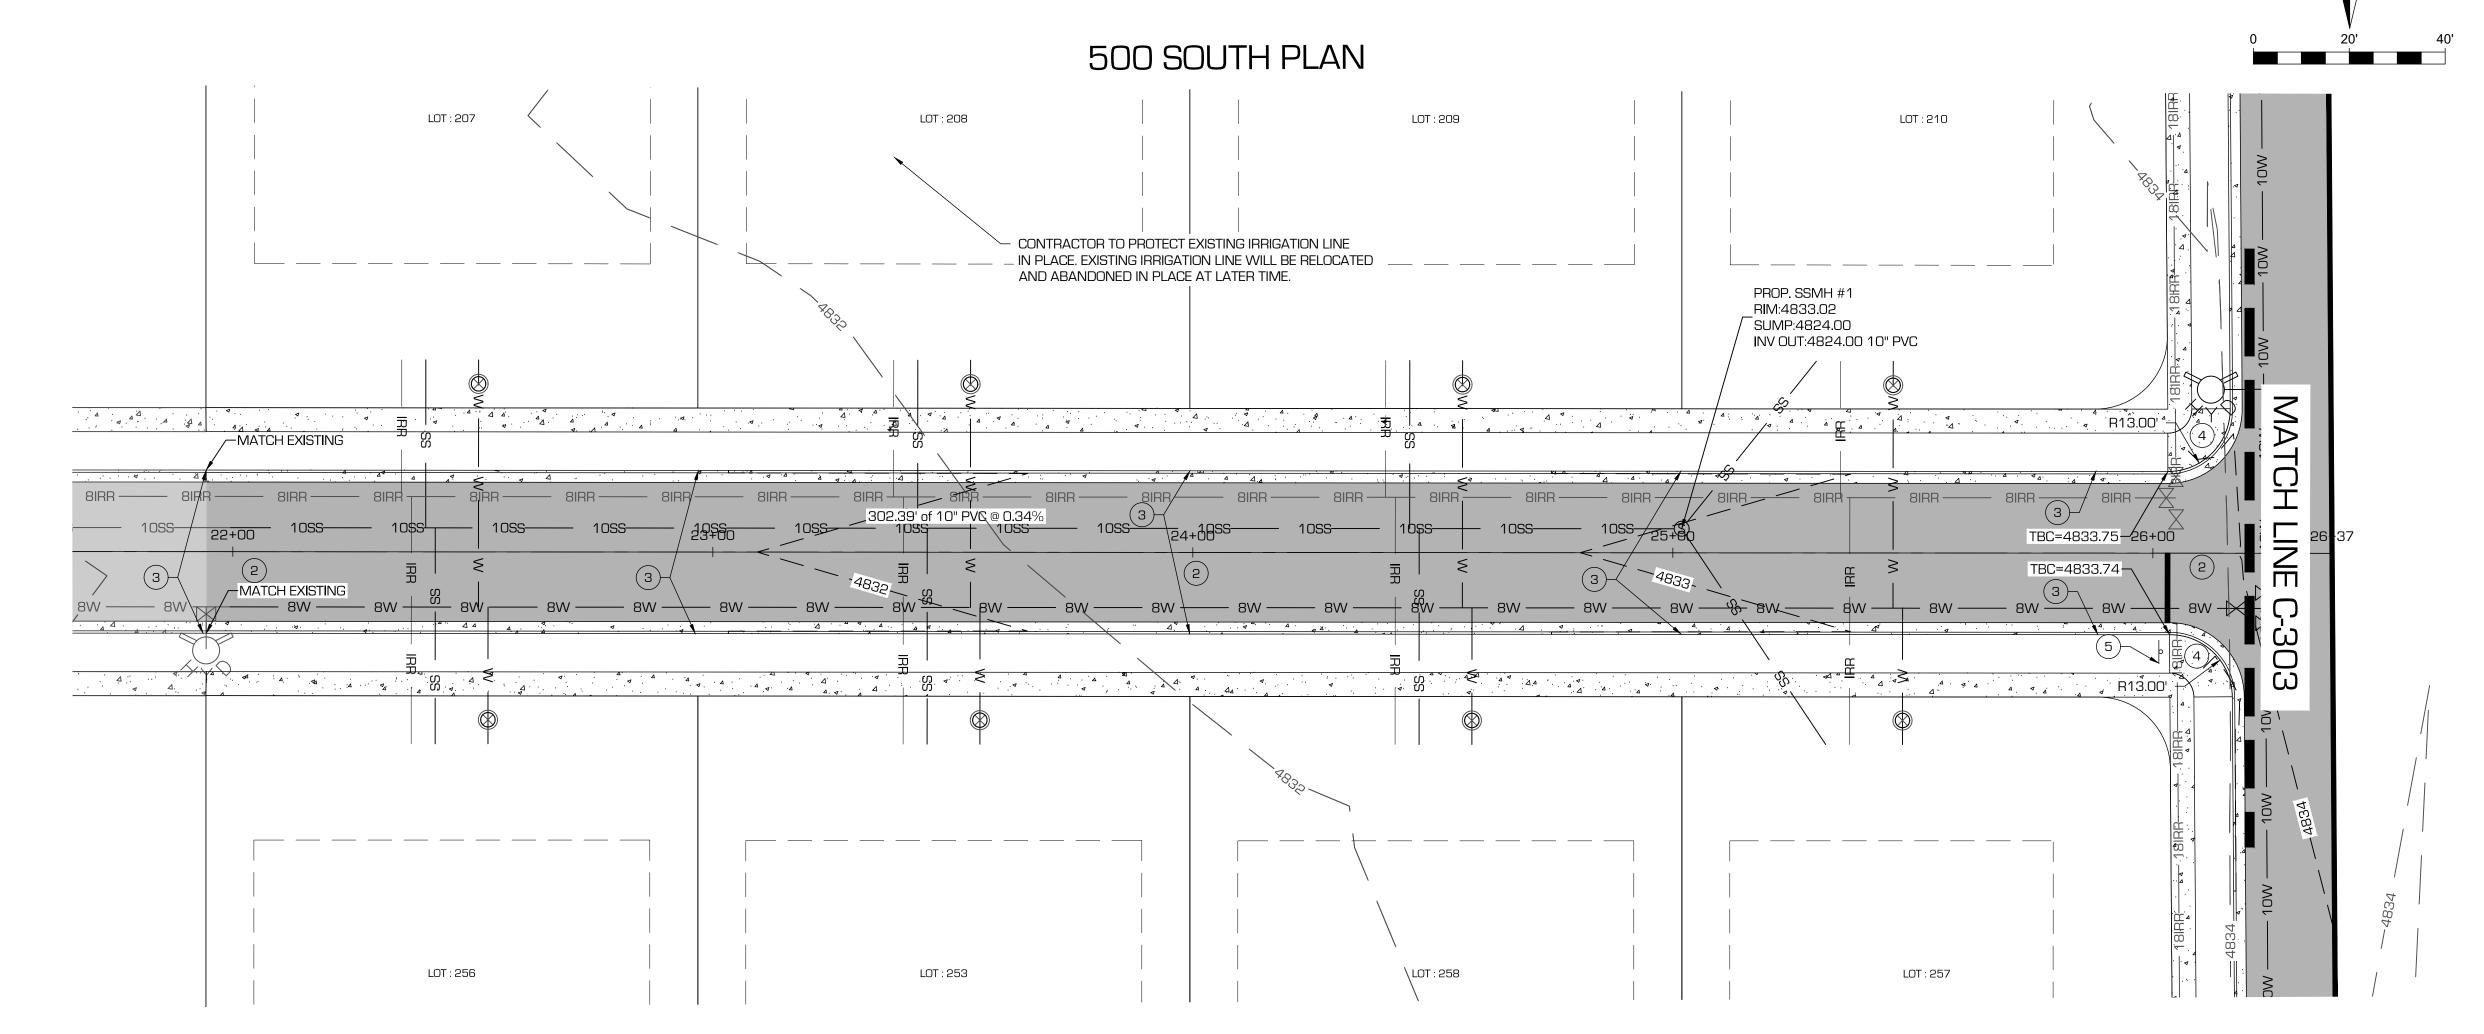

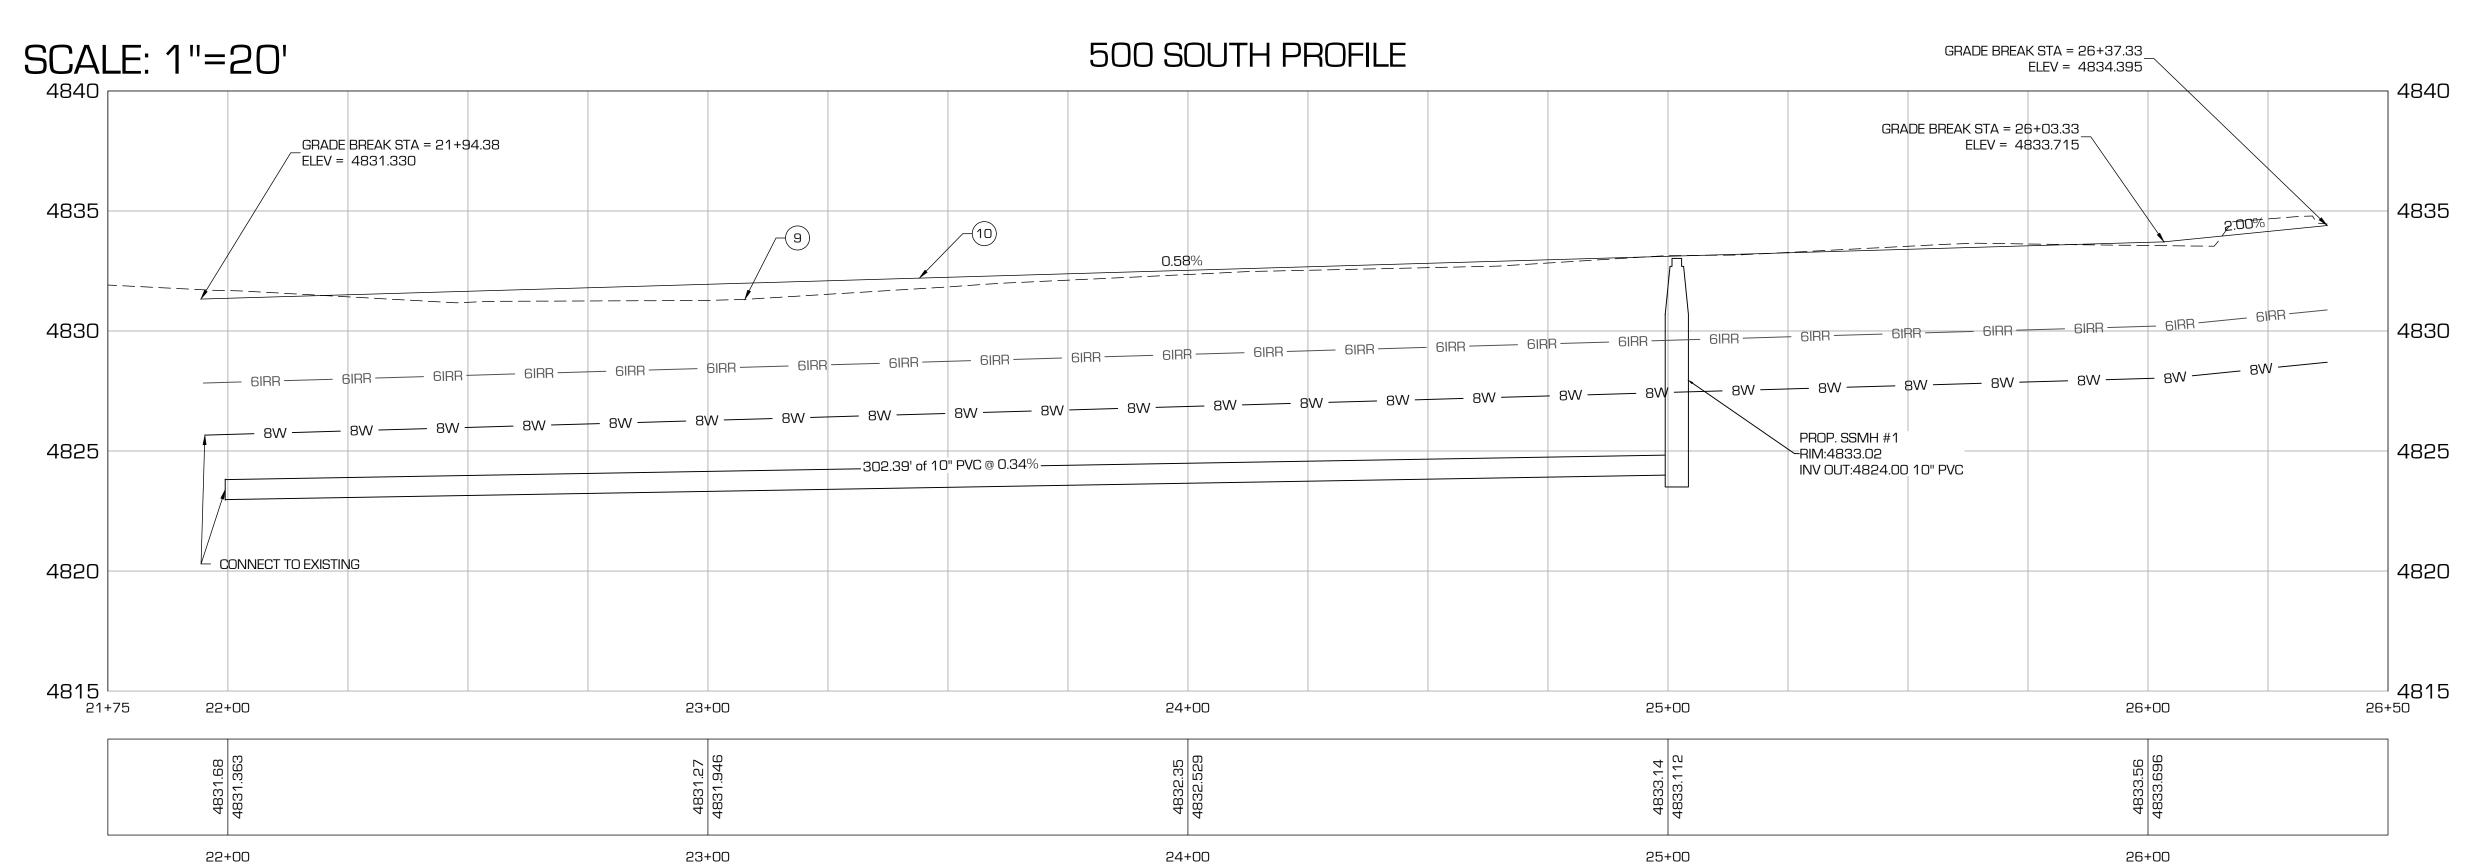

1 SHEET KEY NOTES:

- INSTALL HYRUM CITY 68' ROADWAY CROSS-SECTION
- HALF-WIDTH PER STANDARD DETAIL 05 ON SHEET C-502. INSTALL HYRUM CITY 60' ROADWAY CROSS-SECTION PER
- STANDARD DETAIL 01 ON SHEET C-502. INSTALL STORM DRAIN CURB SCUPPER PER STANDARD DETAIL
- 07 ON SHEET C-502. INSTALL TYPE 2 ADA RAMP PER STANDARD DETAIL 02 ON SHEET
- C-502 UNLESS OTHERWISE STATED IN PLANS.
- INSTALL STOP SIGN AND STOP BAR PAVEMENT MARKING. CAP, BLOCK, AND MARK END OF LINE PER STANDARD DETAIL 07
- INSTALL FIRE HYDRANT ASSEMBLY PER STANDARD DETAIL 02
- ON SHEET C-501. CONTRACTOR SHALL BRING SOIL TO GRADE WHEN HYDRANTS LOCATED IN PARK STRIP SWALES. INSTALL VALVE ON EACH CONNECTING/IRRIGATION LEG PER
- STANDARD DETAIL 05 ON SHEET C-501
- EXISTING GROUND 10. PROPOSED GRADE OF ROADWAY CENTERLINE.

GENERAL NOTES:

- CONTRACTOR TO FIELD VERIFY ALL EXISTING UTILITY LOCATIONS DISPLAYED ON THESE PLANS
- WATER MAIN AND SEWER MAIN WERE LINES INTERSECT.
- MINIMUM OF 10' FROM OUTSIDE-OF-PIPE TO OUTSIDE-OF-PIPE
- FOUND IN STANDARD DRAWING 04 ON SHEET C-501. . ALL CULINARY WATER AND IRRIGATION LINES SHALL BE AWWA C900 DR18. ALL WATER MAINS SHALL BE INSTALLED WITH A MINIMUM OF 5' OF COVER, AND IRRIGATION LINES WITH A MINIMUM OF 3' OF COVER.
- 7. ALL WATER SERVICES SHALL BE INSTALLED PER STANDARD COPPER WITH 24" "WHITE" BARRELS. THE CITY WILL PROVIDE AND SET THE METERS. ALL OTHER PARTS (SERVICE LATERAL PIPING, SETTERS, BARRELS, ETC.) SHALL BE PROVIDED AND INSTALLED BY THE CONTRACTOR. PRIOR TO INSTALLATION OF BARRELS, LOCATIONS SHALL BE DETERMINED USING CONSTRUCTION STAKING METHODS.
- 8. ALL SEWER SERVICES SHALL BE INSTALLED PER STANDARD DETAIL 1 ON SHEET C-501. 9. ALL SEWER LINES SHALL BE CONSTRUCTED OF PVC SDR-35
- 10. ALL SEWER MANHOLES SHALL BE INSTALLED PER STANDARD
- DETAIL 6 ON SHEET C-501. 11. ALL SECONDARY IRRIGATION SERVICES SHALL BE INSTALLED PER
- STANDARD DETAIL 3 ON SHEET C-501. 12. ALL IRRIGATION MAIN PIPE SHALL BE "PURPLE PIPE" FOR USE
- WITH RECLAIMED WATER SYSTEMS AS IS REQUIRED BY STATE REGULATIONS. 13. SEWER CONNECTIONS TO SEWER MANHOLES SHALL BE
- GROUTED USING NON-SHRINK GROUT. 10. CONTRACTOR SHALL PLACE CONCRETE THRUST BLOCKS ON ALL TEES, WYES, BENDS, ANGLES, ETC ON ALL WATER AND
- IRRIGATION LINES AS SHOWN IN DETAIL 07 ON SHEET C-501. 11. POWER - CONTRACTOR SHALL COORDINATE WITH OWNER AND ROCKY MOUNTAIN POWER TO DETERMINE PRECISE LOCATION AND LAYOUT OF POWER LINES THROUGH DEVELOPMENT. CONTRACTOR SHALL BE RESPONSIBLE TO TRENCH, BED, INSTALL AND FILL IN THE POWER TRENCH AND PROVIDE THE REQUIRED
- PVC SCHEDULE 40 CONDUIT. 12. TELEPHONE AND CABLE - CONTRACTOR SHALL COORDINATE WITH UTILITY COMPANIES FOR LOCATION OF CONDUIT CROSSINGS AND SHALL INSTALL ALL CONDUITS.
- 13. GAS CONTRACTOR SHALL COORDINATE INSTALLATION OF GAS WITH QUESTAR GAS. 14. CONTRACTOR SHALL INSTALL WIRING JUNCTION FOR STREET
- MOUNTAIN POWER. STREET LIGHTS SHALL BE INSTALLED BY ROCKY MOUNTAIN POWER AND HYRUM CITY.

LIGHTS AT LOCATIONS PER CITY REQUIREMENTS AND ROCKY

15. CONTRACTOR SHALL NOT EXCAVATE ROAD SIDE SWALES UNTIL ALL UTILITIES HAVE BEEN INSTALLED.



THESE PLANS AND SPECIFICATIONS ARE THE PROPERTY OF CIVIL SOLUTIONS GROUP, INC, AN SHALL NOT BE PHOTOCOPIED, RE-DRAWN, OR USED ON ANY OTHER PROJECT OTHER THAN THE PROJECT SPECIFICALLY DESIGNED FOR, WITHOUT WRITTEN PERMISSION. THE OWNERS AND ENGINEERS OF CIVIL SOLUTIONS GROUP, INC. DISCLAIM ANY LIABILITY FOR ANY CHANGES OR MODIFICATIONS MADE TO THESE PLANS OR THE DESIGN THEREON WITHOUT THEIR CONSENT. THESE PLANS ARE DRAWN TO SCALE WHEN PLOTTED ON A 24" X 36" SHEET OF

0

lutions

PROJECT #: DRAWN BY:


C. BOWN

M. TAYLOR PROJECT MANAGER: M. TALYOR DESIGNED BY:

ISSUED: 03.29.18



SITE/UTILITY C-301

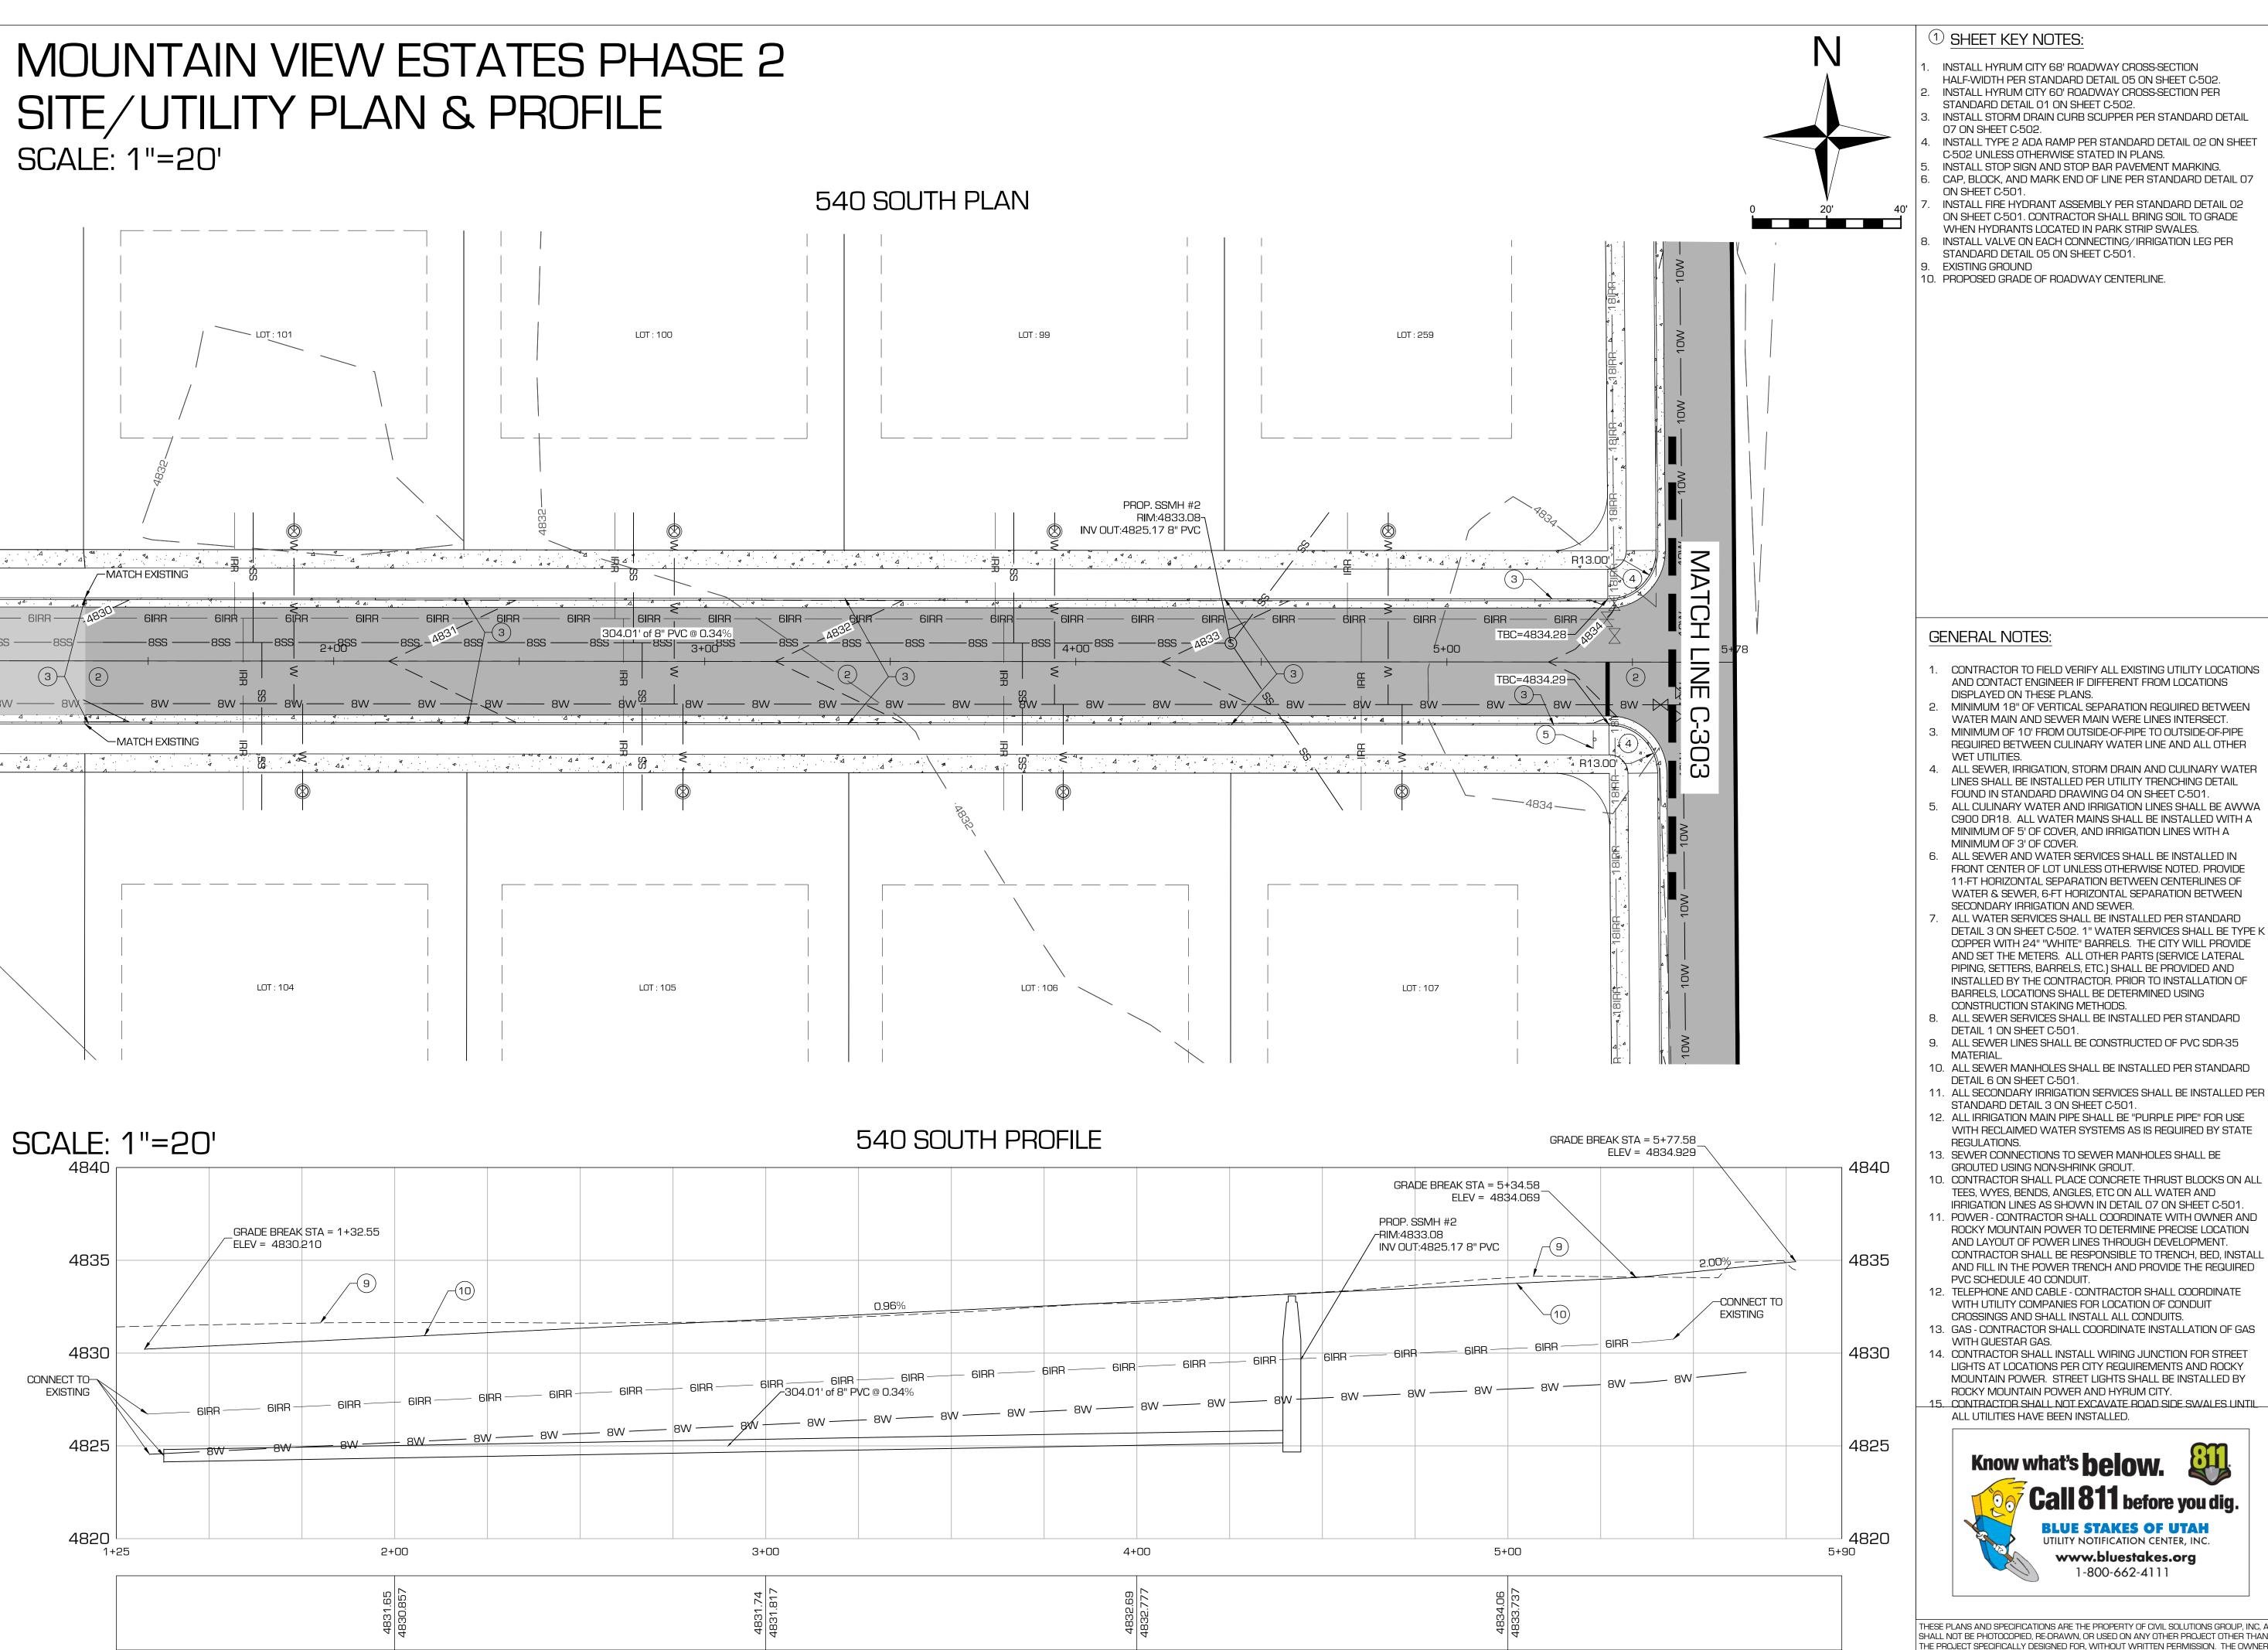

4+00

-LEADERS IN SUSTAINABLE ENGINEERING AND PLANNING-

5+00

2+00

3+00

1 SHEET KEY NOTES:

- HALF-WIDTH PER STANDARD DETAIL 05 ON SHEET C-502. INSTALL HYRUM CITY 60' ROADWAY CROSS-SECTION PER
- STANDARD DETAIL 01 ON SHEET C-502. INSTALL STORM DRAIN CURB SCUPPER PER STANDARD DETAIL
- 07 ON SHEET C-502.
- INSTALL TYPE 2 ADA RAMP PER STANDARD DETAIL 02 ON SHEET C-502 UNLESS OTHERWISE STATED IN PLANS.
- INSTALL STOP SIGN AND STOP BAR PAVEMENT MARKING.
- INSTALL FIRE HYDRANT ASSEMBLY PER STANDARD DETAIL 02

- 10. PROPOSED GRADE OF ROADWAY CENTERLINE.

6

lutions

S

- I. CONTRACTOR TO FIELD VERIFY ALL EXISTING UTILITY LOCATIONS AND CONTACT ENGINEER IF DIFFERENT FROM LOCATIONS
- MINIMUM 18" OF VERTICAL SEPARATION REQUIRED BETWEEN

- MINIMUM OF 5' OF COVER, AND IRRIGATION LINES WITH A MINIMUM OF 3' OF COVER.
- 11-FT HORIZONTAL SEPARATION BETWEEN CENTERLINES OF WATER & SEWER. 6-FT HORIZONTAL SEPARATION BETWEEN SECONDARY IRRIGATION AND SEWER.
- 7. ALL WATER SERVICES SHALL BE INSTALLED PER STANDARD DETAIL 3 ON SHEET C-502. 1" WATER SERVICES SHALL BE TYPE K COPPER WITH 24" "WHITE" BARRELS. THE CITY WILL PROVIDE AND SET THE METERS. ALL OTHER PARTS (SERVICE LATERAL PIPING, SETTERS, BARRELS, ETC.) SHALL BE PROVIDED AND INSTALLED BY THE CONTRACTOR. PRIOR TO INSTALLATION OF BARRELS, LOCATIONS SHALL BE DETERMINED USING CONSTRUCTION STAKING METHODS.
- 8. ALL SEWER SERVICES SHALL BE INSTALLED PER STANDARD DETAIL 1 ON SHEET C-501.
- 9. ALL SEWER LINES SHALL BE CONSTRUCTED OF PVC SDR-35
- 10. ALL SEWER MANHOLES SHALL BE INSTALLED PER STANDARD DETAIL 6 ON SHEET C-501.
- STANDARD DETAIL 3 ON SHEET C-501. 12. ALL IRRIGATION MAIN PIPE SHALL BE "PURPLE PIPE" FOR USE
- WITH RECLAIMED WATER SYSTEMS AS IS REQUIRED BY STATE REGULATIONS.
- 13. SEWER CONNECTIONS TO SEWER MANHOLES SHALL BE
- GROUTED USING NON-SHRINK GROUT. 10. CONTRACTOR SHALL PLACE CONCRETE THRUST BLOCKS ON ALL
- TEES, WYES, BENDS, ANGLES, ETC ON ALL WATER AND IRRIGATION LINES AS SHOWN IN DETAIL 07 ON SHEET C-501.
- 11. POWER CONTRACTOR SHALL COORDINATE WITH OWNER AND ROCKY MOUNTAIN POWER TO DETERMINE PRECISE LOCATION AND LAYOUT OF POWER LINES THROUGH DEVELOPMENT. CONTRACTOR SHALL BE RESPONSIBLE TO TRENCH, BED, INSTALL AND FILL IN THE POWER TRENCH AND PROVIDE THE REQUIRED PVC SCHEDULE 40 CONDUIT.
- 12. TELEPHONE AND CABLE CONTRACTOR SHALL COORDINATE WITH UTILITY COMPANIES FOR LOCATION OF CONDUIT CROSSINGS AND SHALL INSTALL ALL CONDUITS.
- 13. GAS CONTRACTOR SHALL COORDINATE INSTALLATION OF GAS WITH QUESTAR GAS.
- 14. CONTRACTOR SHALL INSTALL WIRING JUNCTION FOR STREET LIGHTS AT LOCATIONS PER CITY REQUIREMENTS AND ROCKY MOUNTAIN POWER. STREET LIGHTS SHALL BE INSTALLED BY ROCKY MOUNTAIN POWER AND HYRUM CITY.
- 15. CONTRACTOR SHALL NOT EXCAVATE ROAD SIDE SWALES UNTIL



THESE PLANS AND SPECIFICATIONS ARE THE PROPERTY OF CIVIL SOLUTIONS GROUP, INC, AN SHALL NOT BE PHOTOCOPIED, RE-DRAWN, OR USED ON ANY OTHER PROJECT OTHER THAN THE PROJECT SPECIFICALLY DESIGNED FOR, WITHOUT WRITTEN PERMISSION. THE OWNERS AND ENGINEERS OF CIVIL SOLUTIONS GROUP, INC. DISCLAIM ANY LIABILITY FOR ANY CHANGES OR MODIFICATIONS MADE TO THESE PLANS OR THE DESIGN THEREON WITHOUT THEIR CONSENT. THESE PLANS ARE DRAWN TO SCALE WHEN PLOTTED ON A 24" X 36" SHEET OF

PROJECT #: DRAWN BY: C. BOWN

PROJECT MANAGER: M. TALYOR

No. 8243188-2202

03.29.18


SITE/UTILITY

C-302


MOUNTAIN VIEW ESTATES PHASE 2 SITE/UTILITY PLAN & PROFILE

SCALE: 1"=30'

HAMMER ROAD PLAN

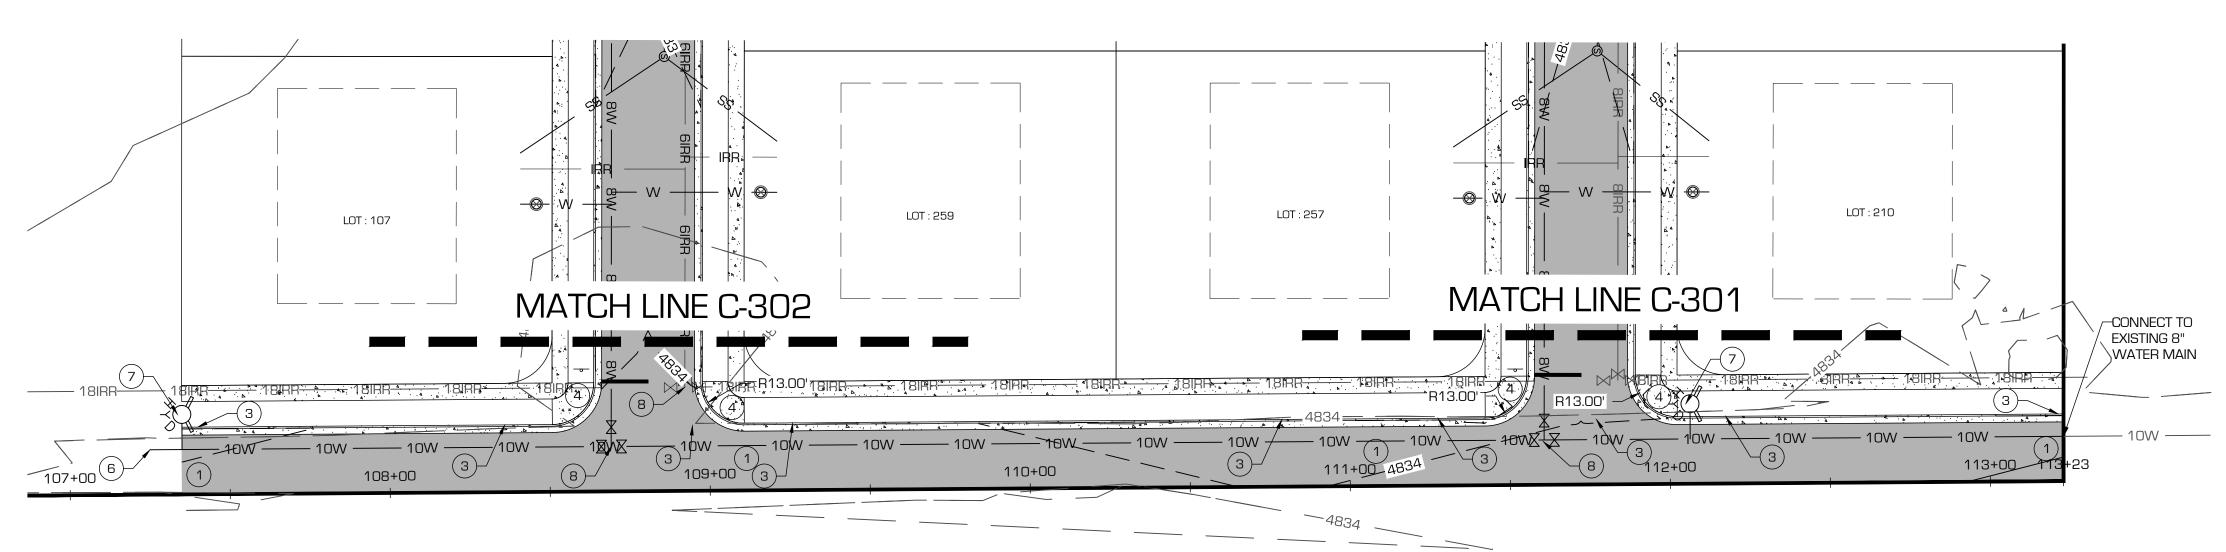

HAMMER ROAD PROFILE SCALE: 1"=30' 4840 GRADE BREAK STA = 107+34.60 GRADE BREAK STA = 110+78.89 GRADE BREAK STA = 113+22.85 GRADE BREAK STA = 108+80.34 ELEV = 4833.930ELEV = 4835.150ELEV = 4834.200ELEV = 4834.9294835 4835 18IRR 4830 4830 $\frac{1}{10} \underbrace{10} \underbrace$ 4825 107+00 108+00 109+00 110+00 111+00 113+00 113+50 112+00 108+00 113+00 109+00 110+00 111+00 112+00

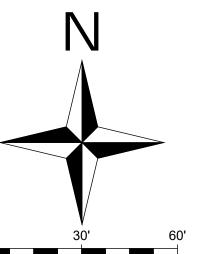

1 SHEET KEY NOTES:

- INSTALL HYRUM CITY 68' ROADWAY CROSS-SECTION HALF-WIDTH PER STANDARD DETAIL 05 ON SHEET C-502.
- INSTALL HYRUM CITY 60' ROADWAY CROSS-SECTION PER STANDARD DETAIL 01 ON SHEET C-502.
- INSTALL STORM DRAIN CURB SCUPPER PER STANDARD DETAIL 07 ON SHEET C-502.
- 4. INSTALL TYPE 2 ADA RAMP PER STANDARD DETAIL 02 ON SHEET C-502 UNLESS OTHERWISE STATED IN PLANS.
- INSTALL STOP SIGN AND STOP BAR PAVEMENT MARKING. CAP, BLOCK, AND MARK END OF LINE PER STANDARD DETAIL 07
- ON SHEET C-501. INSTALL FIRE HYDRANT ASSEMBLY PER STANDARD DETAIL 02 ON SHEET C-501. CONTRACTOR SHALL BRING SOIL TO GRADE
- WHEN HYDRANTS LOCATED IN PARK STRIP SWALES. INSTALL VALVE ON EACH CONNECTING/IRRIGATION LEG PER
- STANDARD DETAIL 05 ON SHEET C-501.
- 9. EXISTING GROUND 10. PROPOSED GRADE OF ROADWAY CENTERLINE.

U pinc.

lutions

S

PROJECT #: DRAWN BY: C. BOWN

PROJECT MANAGER: M. TAYLOR DESIGNED BY M. TALYOR

ISSUED: 03.29.18



SITE/UTILITY C-303

GENERAL NOTES:

- CONTRACTOR TO FIELD VERIFY ALL EXISTING UTILITY LOCATIONS AND CONTACT ENGINEER IF DIFFERENT FROM LOCATIONS DISPLAYED ON THESE PLANS.
- MINIMUM 18" OF VERTICAL SEPARATION REQUIRED BETWE WATER MAIN AND SEWER MAIN WERE LINES INTERSECT.
- MINIMUM OF 10' FROM OUTSIDE-OF-PIPE TO OUTSIDE-OF-PIPE WET UTILITIES.
- LINES SHALL BE INSTALLED PER UTILITY TRENCHING DETAIL FOUND IN STANDARD DRAWING 04 ON SHEET C-501. ALL CULINARY WATER AND IRRIGATION LINES SHALL BE AWWA C900 DR18. ALL WATER MAINS SHALL BE INSTALLED WITH A MINIMUM OF 5' OF COVER, AND IRRIGATION LINES WITH A MINIMUM OF 3' OF COVER.
- ALL SEWER AND WATER SERVICES SHALL BE INSTALLED IN FRONT CENTER OF LOT UNLESS OTHERWISE NOTED. PROVIDE 11-FT HORIZONTAL SEPARATION BETWEEN CENTERLINES OF WATER & SEWER, 6-FT HORIZONTAL SEPARATION BETWEEN SECONDARY IRRIGATION AND SEWER.
- 7. ALL WATER SERVICES SHALL BE INSTALLED PER STANDARD COPPER WITH 24" "WHITE" BARRELS. THE CITY WILL PROVIDE AND SET THE METERS. ALL OTHER PARTS (SERVICE LATERAL PIPING, SETTERS, BARRELS, ETC.) SHALL BE PROVIDED AND INSTALLED BY THE CONTRACTOR. PRIOR TO INSTALLATION OF BARRELS, LOCATIONS SHALL BE DETERMINED USING CONSTRUCTION STAKING METHODS.
- 8. ALL SEWER SERVICES SHALL BE INSTALLED PER STANDARD DETAIL 1 ON SHEET C-501. 9. ALL SEWER LINES SHALL BE CONSTRUCTED OF PVC SDR-35
- 10. ALL SEWER MANHOLES SHALL BE INSTALLED PER STANDARD DETAIL 6 ON SHEET C-501.
- 11. ALL SECONDARY IRRIGATION SERVICES SHALL BE INSTALLED PER STANDARD DETAIL 3 ON SHEET C-501. 12. ALL IRRIGATION MAIN PIPE SHALL BE "PURPLE PIPE" FOR USE
- WITH RECLAIMED WATER SYSTEMS AS IS REQUIRED BY STATE REGULATIONS. 13. SEWER CONNECTIONS TO SEWER MANHOLES SHALL BE
- GROUTED USING NON-SHRINK GROUT. 10. CONTRACTOR SHALL PLACE CONCRETE THRUST BLOCKS ON ALL TEES, WYES, BENDS, ANGLES, ETC ON ALL WATER AND
- IRRIGATION LINES AS SHOWN IN DETAIL 07 ON SHEET C-501. 11. POWER - CONTRACTOR SHALL COORDINATE WITH OWNER AND ROCKY MOUNTAIN POWER TO DETERMINE PRECISE LOCATION AND LAYOUT OF POWER LINES THROUGH DEVELOPMENT. CONTRACTOR SHALL BE RESPONSIBLE TO TRENCH, BED, INSTALL AND FILL IN THE POWER TRENCH AND PROVIDE THE REQUIRED
- PVC SCHEDULE 40 CONDUIT. 12. TELEPHONE AND CABLE - CONTRACTOR SHALL COORDINATE WITH UTILITY COMPANIES FOR LOCATION OF CONDUIT CROSSINGS AND SHALL INSTALL ALL CONDUITS.
- 13. GAS CONTRACTOR SHALL COORDINATE INSTALLATION OF GAS WITH QUESTAR GAS. 14. CONTRACTOR SHALL INSTALL WIRING JUNCTION FOR STREET LIGHTS AT LOCATIONS PER CITY REQUIREMENTS AND ROCKY
- MOUNTAIN POWER. STREET LIGHTS SHALL BE INSTALLED BY ROCKY MOUNTAIN POWER AND HYRUM CITY. 15. CONTRACTOR SHALL NOT EXCAVATE ROAD SIDE SWALES UNTIL


ALL UTILITIES HAVE BEEN INSTALLED.




THESE PLANS AND SPECIFICATIONS ARE THE PROPERTY OF CIVIL SOLUTIONS GROUP, INC, AN SHALL NOT BE PHOTOCOPIED, RE-DRAWN, OR USED ON ANY OTHER PROJECT OTHER THAN THE PROJECT SPECIFICALLY DESIGNED FOR. WITHOUT WRITTEN PERMISSION. THE OWNERS AND ENGINEERS OF CIVIL SOLUTIONS GROUP, INC. DISCLAIM ANY LIABILITY FOR ANY CHANGES OR MODIFICATIONS MADE TO THESE PLANS OR THE DESIGN THEREON WITHOUT THEIR CONSENT. THESE PLANS ARE DRAWN TO SCALE WHEN PLOTTED ON A 24" X 36" SHEET OF

MOUNTAIN VIEW ESTATES PHASE 2 STANDARD DETAILS

SCALE: NTS

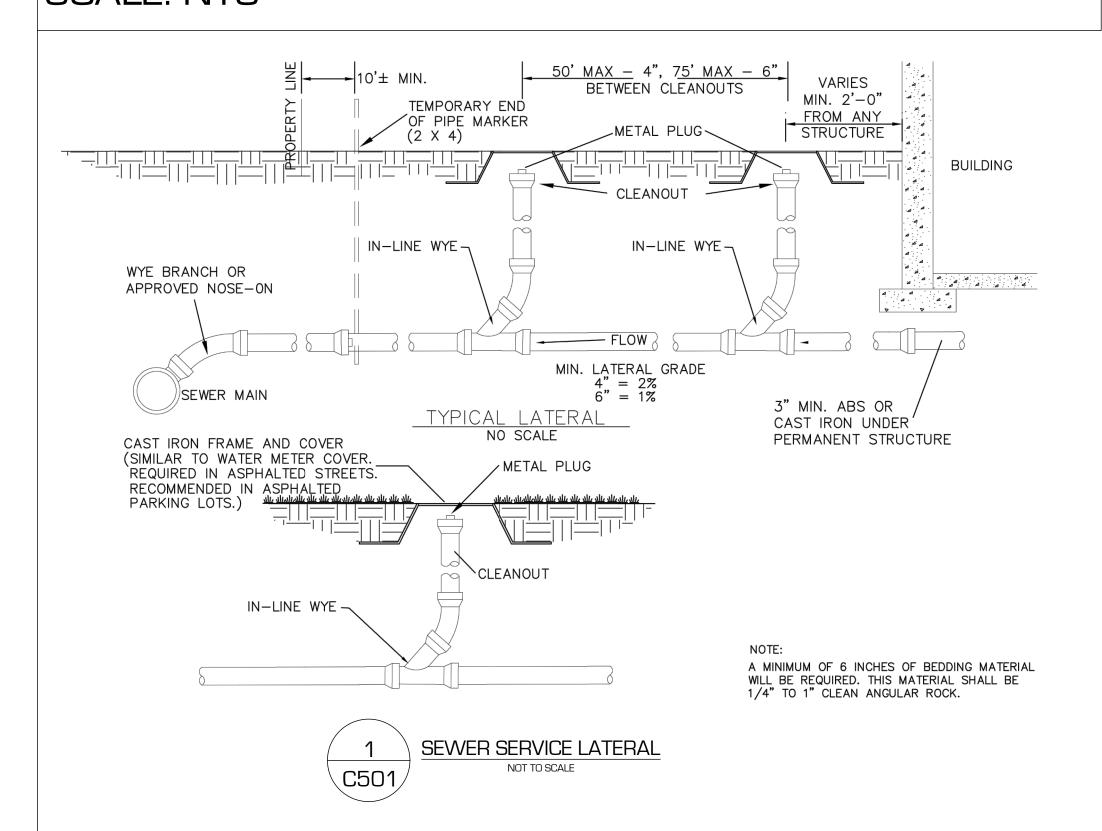


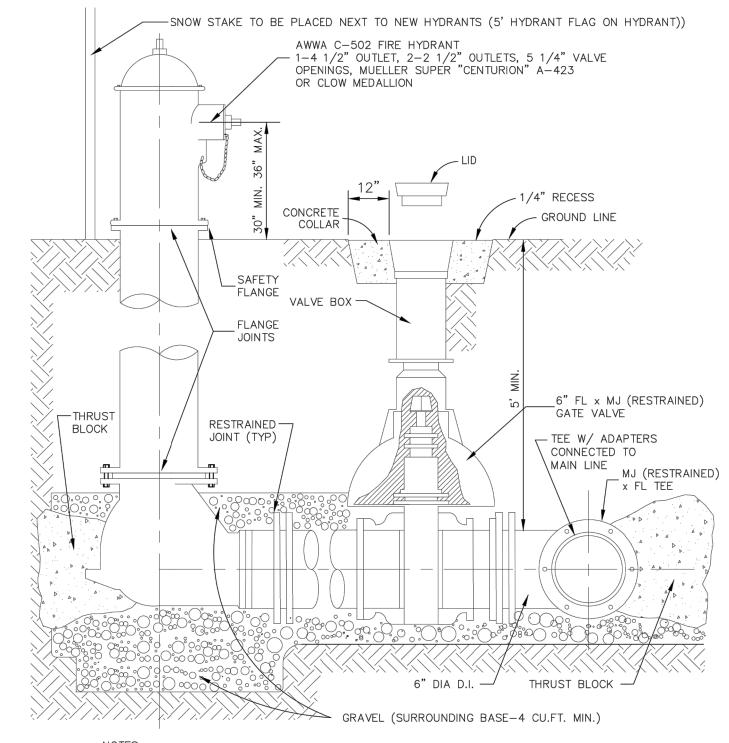


1. ALL FIRE HYDRANTS SHALL BE LOCATED AS SHOWN ON THE PLANS.

- ALL FIRE HYDRANTS WILL STAND PLUMB WITH THE PUMPER NOZZLE FACING THE STREET. 3. THE VALVE WILL BE LOCATED AS APPROVED BY CITY.
- PIPE MATERIAL SHALL BE DUCTILE. 4. FOR DETAILED INFORMATION SEE SPECIFICATIONS. RESTRAIN ALL JOINTS FROM MAIN TO FIRE HYDRANT.
- CONCRETE VALVE COLLAR SHALL BE BROOM FINISHED IN RADIAL PATTERN.


FIRE HYDRANT DETAIL NOT TO SCALE

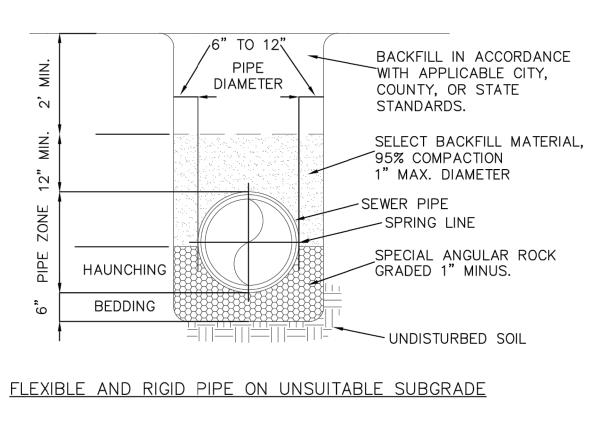


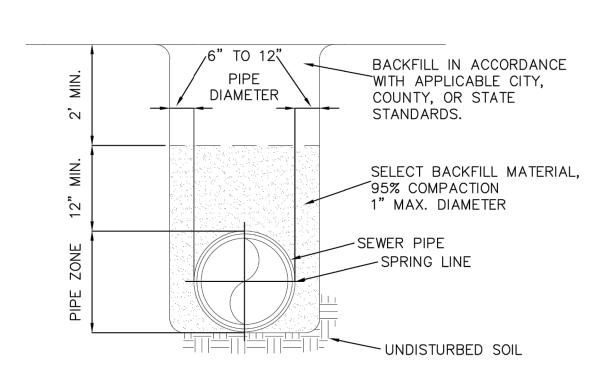


RIGID PIPE ON SUITABLE SUBGRADE


PIPE TRENCH DETAIL NOT TO SCALE

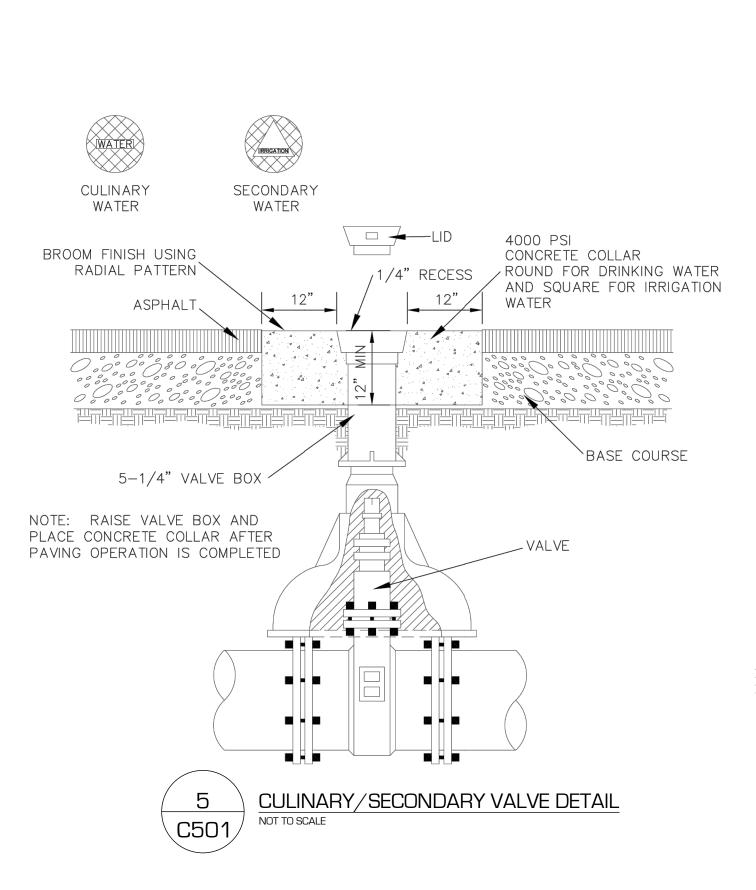


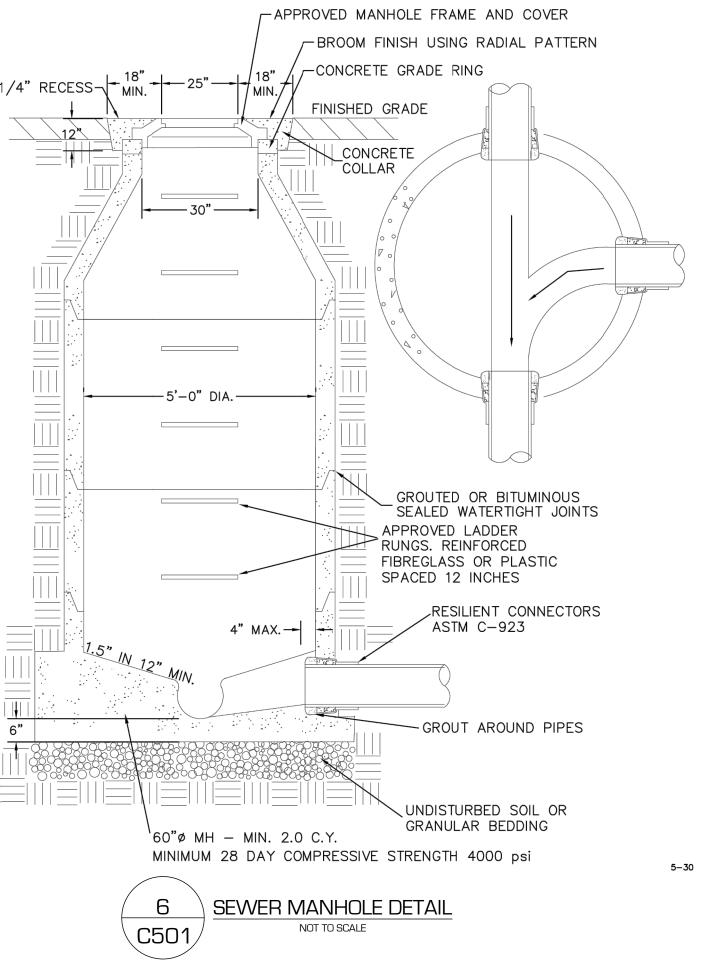

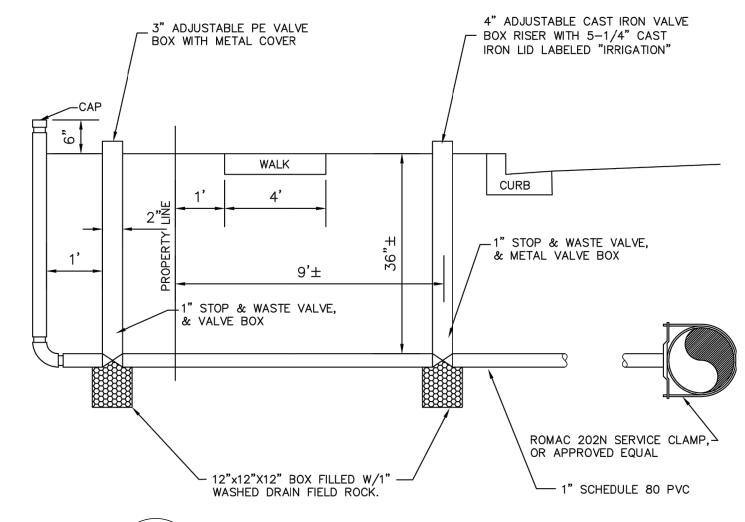

SECONDARY IRRIGATION SERVICE CONNECTION

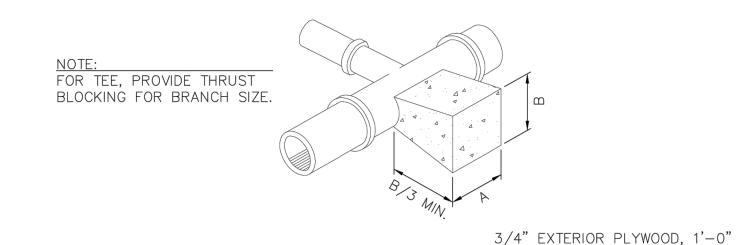

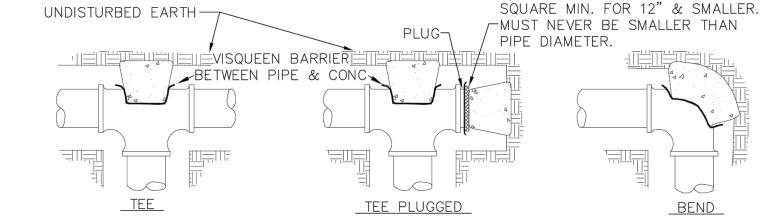

DIMENSIONS FOR THRUST BLOCKING								
FITTING	FITTING TEES & PLUGS 90		90° E	90° BENDS 45° BENDS & "Y"S		22 1/2° BENDS		
SIZES	А	В	Α	В	Α	В	А	В
4"	1'-6"	1'-6"	1'-6"	1'-9"	1'-3"	0'-6"	1'-0"	0'-6"
6"	2'-0"	1'-0"	2'-0"	2'-0"	1'-3"	1'-6"	1'-0"	1'-5"
8"	2'-0"	1'-6"	2'-3"	2'-3"	1'-8"	1'-8"	1'-0"	1'-3"
10"	2'-6"	2'-3"	2'-9"	2'-10"	2'-3"	1'-10"	1'-3"	2'-0"
12"	3'-0"	2'-9"	3'-6"	3'-3"	2'-6"	2'-4"	2'-0"	1'-6"
14"	3'-5"	3'-0"	4'-0"	3'-8"	3'-6"	2'-4"	2'-0"	2'-3"
16"	4'-0'	3'-6"	5'-0"	4'-0"	3'-6"	3'-0"	2'-6"	2'-3"
18"	4'-0"	4'-3"	6'-0"	4'-0"	4'-0"	3'-3"	2'-9"	2'-6"
20"	5'-0"	4'-3"	6'-0"	5'-0"	4'-3"	4'-0"	3'-0"	2'-9"
24"	6'-0"	5'-3"	8'-0"	5'-6"	6'-0"	4'-0"	4'-0"	3'-0"

NOTES:

- 1. THIS TABLE IS BASED ON 200 P.S.I. MAIN PRESSURE AND 2000 P.S.F. SOIL BEARING PRESSURE. ADJUST BEARING AREAS IN ACCORDANCE WITH SOIL CONDITIONS AND PRESSURES ENCOUNTERED.
- 2. FOR ASBESTOS CEMENT PIPE GREATER THAN 6 INCHES IN DIAMETER DOUBLE THE AREA REQUIRED IN THE TABLE ABOVE.
- 3. USE VISQUEEN BETWEEN CONCRETE AND PIPE.
- 4. REFER TO CONCRETE STANDARD SPECIFICATIONS. 5. THE "THRUST BLOCKING DETAILS" IN NO WAY LIMITS THE LOCATION OR SIZE OF ADDITIONAL BLOCKING WHEN SO WARRANTED OR REQUIRED BY THE ENGINEER.






THESE PLANS AND SPECIFICATIONS ARE THE PROPERTY OF CIVIL SOLUTIONS GROUP, INC, AN SHALL NOT BE PHOTOCOPIED, RE-DRAWN, OR USED ON ANY OTHER PROJECT OTHER THAN THE PROJECT SPECIFICALLY DESIGNED FOR, WITHOUT WRITTEN PERMISSION. THE OWNERS AND ENGINEERS OF CIVIL SOLUTIONS GROUP, INC. DISCLAIM ANY LIABILITY FOR ANY CHANGES OR MODIFICATIONS MADE TO THESE PLANS OR THE DESIGN THEREON WITHOUT THEIR CONSENT. THESE PLANS ARE DRAWN TO SCALE WHEN PLOTTED ON A 24" X 36" SHEET OF

S

—

S

C

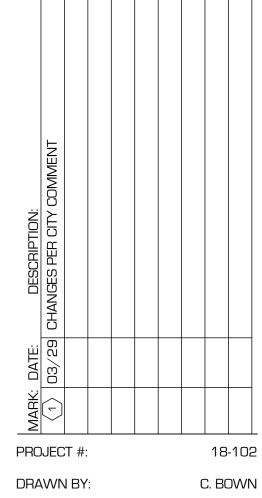


PROJECT MANAGER: M. TAYLOR


M. TALYOR DESIGNED BY: ISSUED: 03.29.18





STANDARD **DETAILS**


C-501

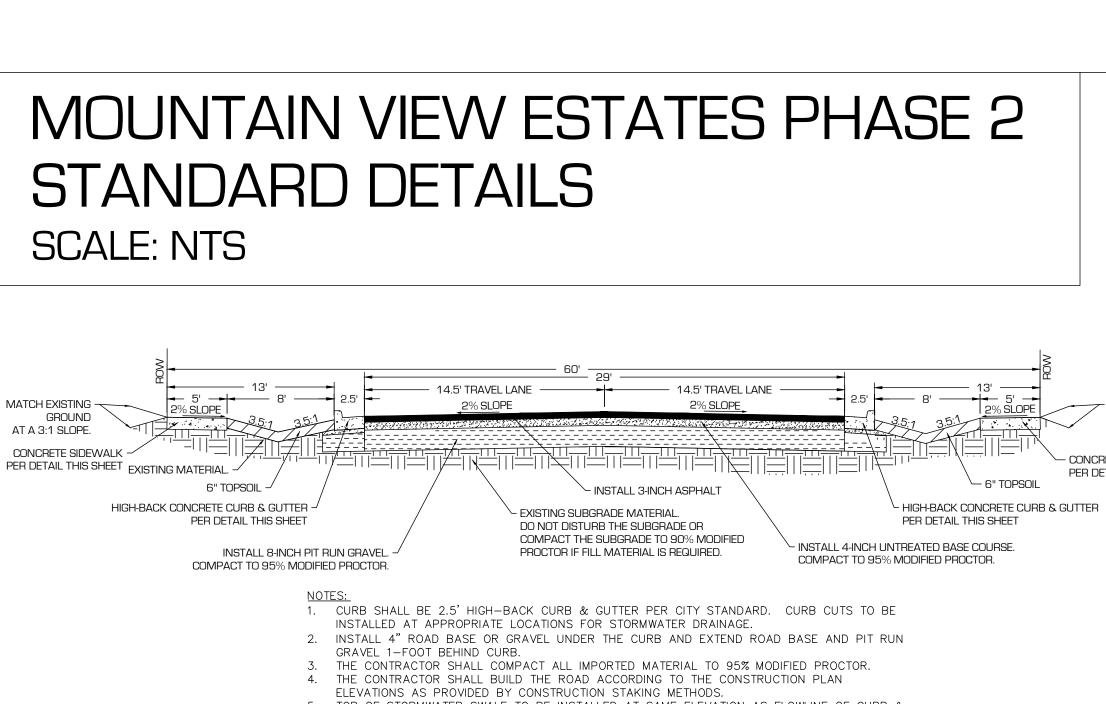

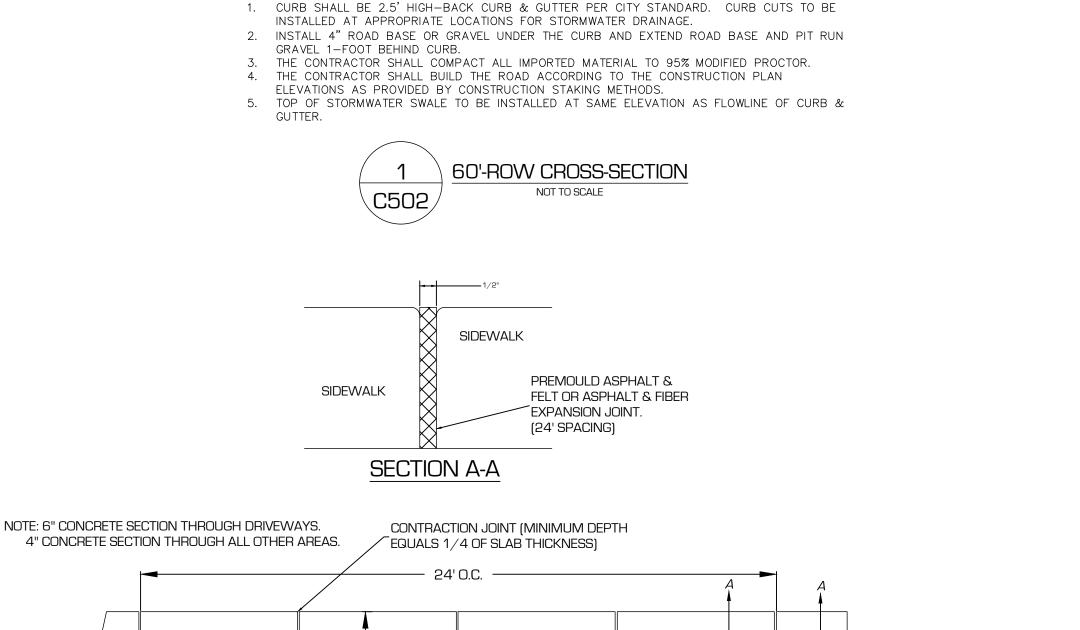

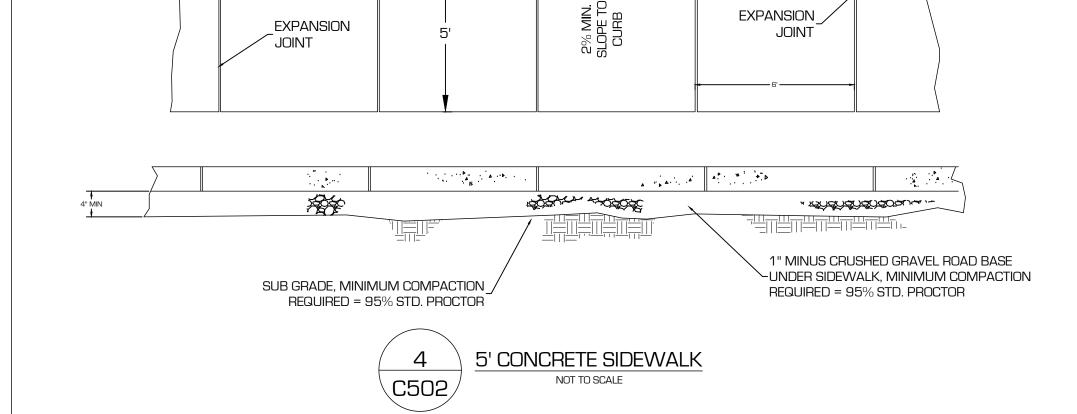

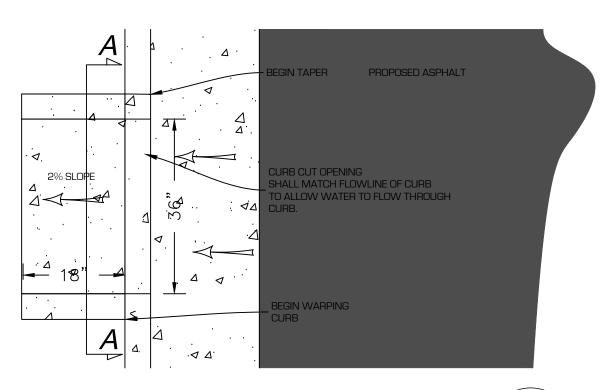

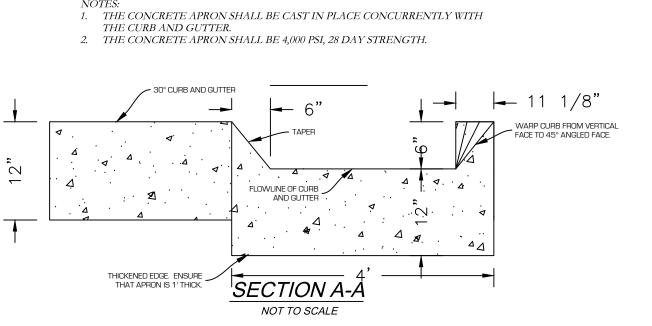


GROUND

CONCRETE SIDEWALK

PER DETAIL THIS SHEET

AT A 3:1 SLOPE.



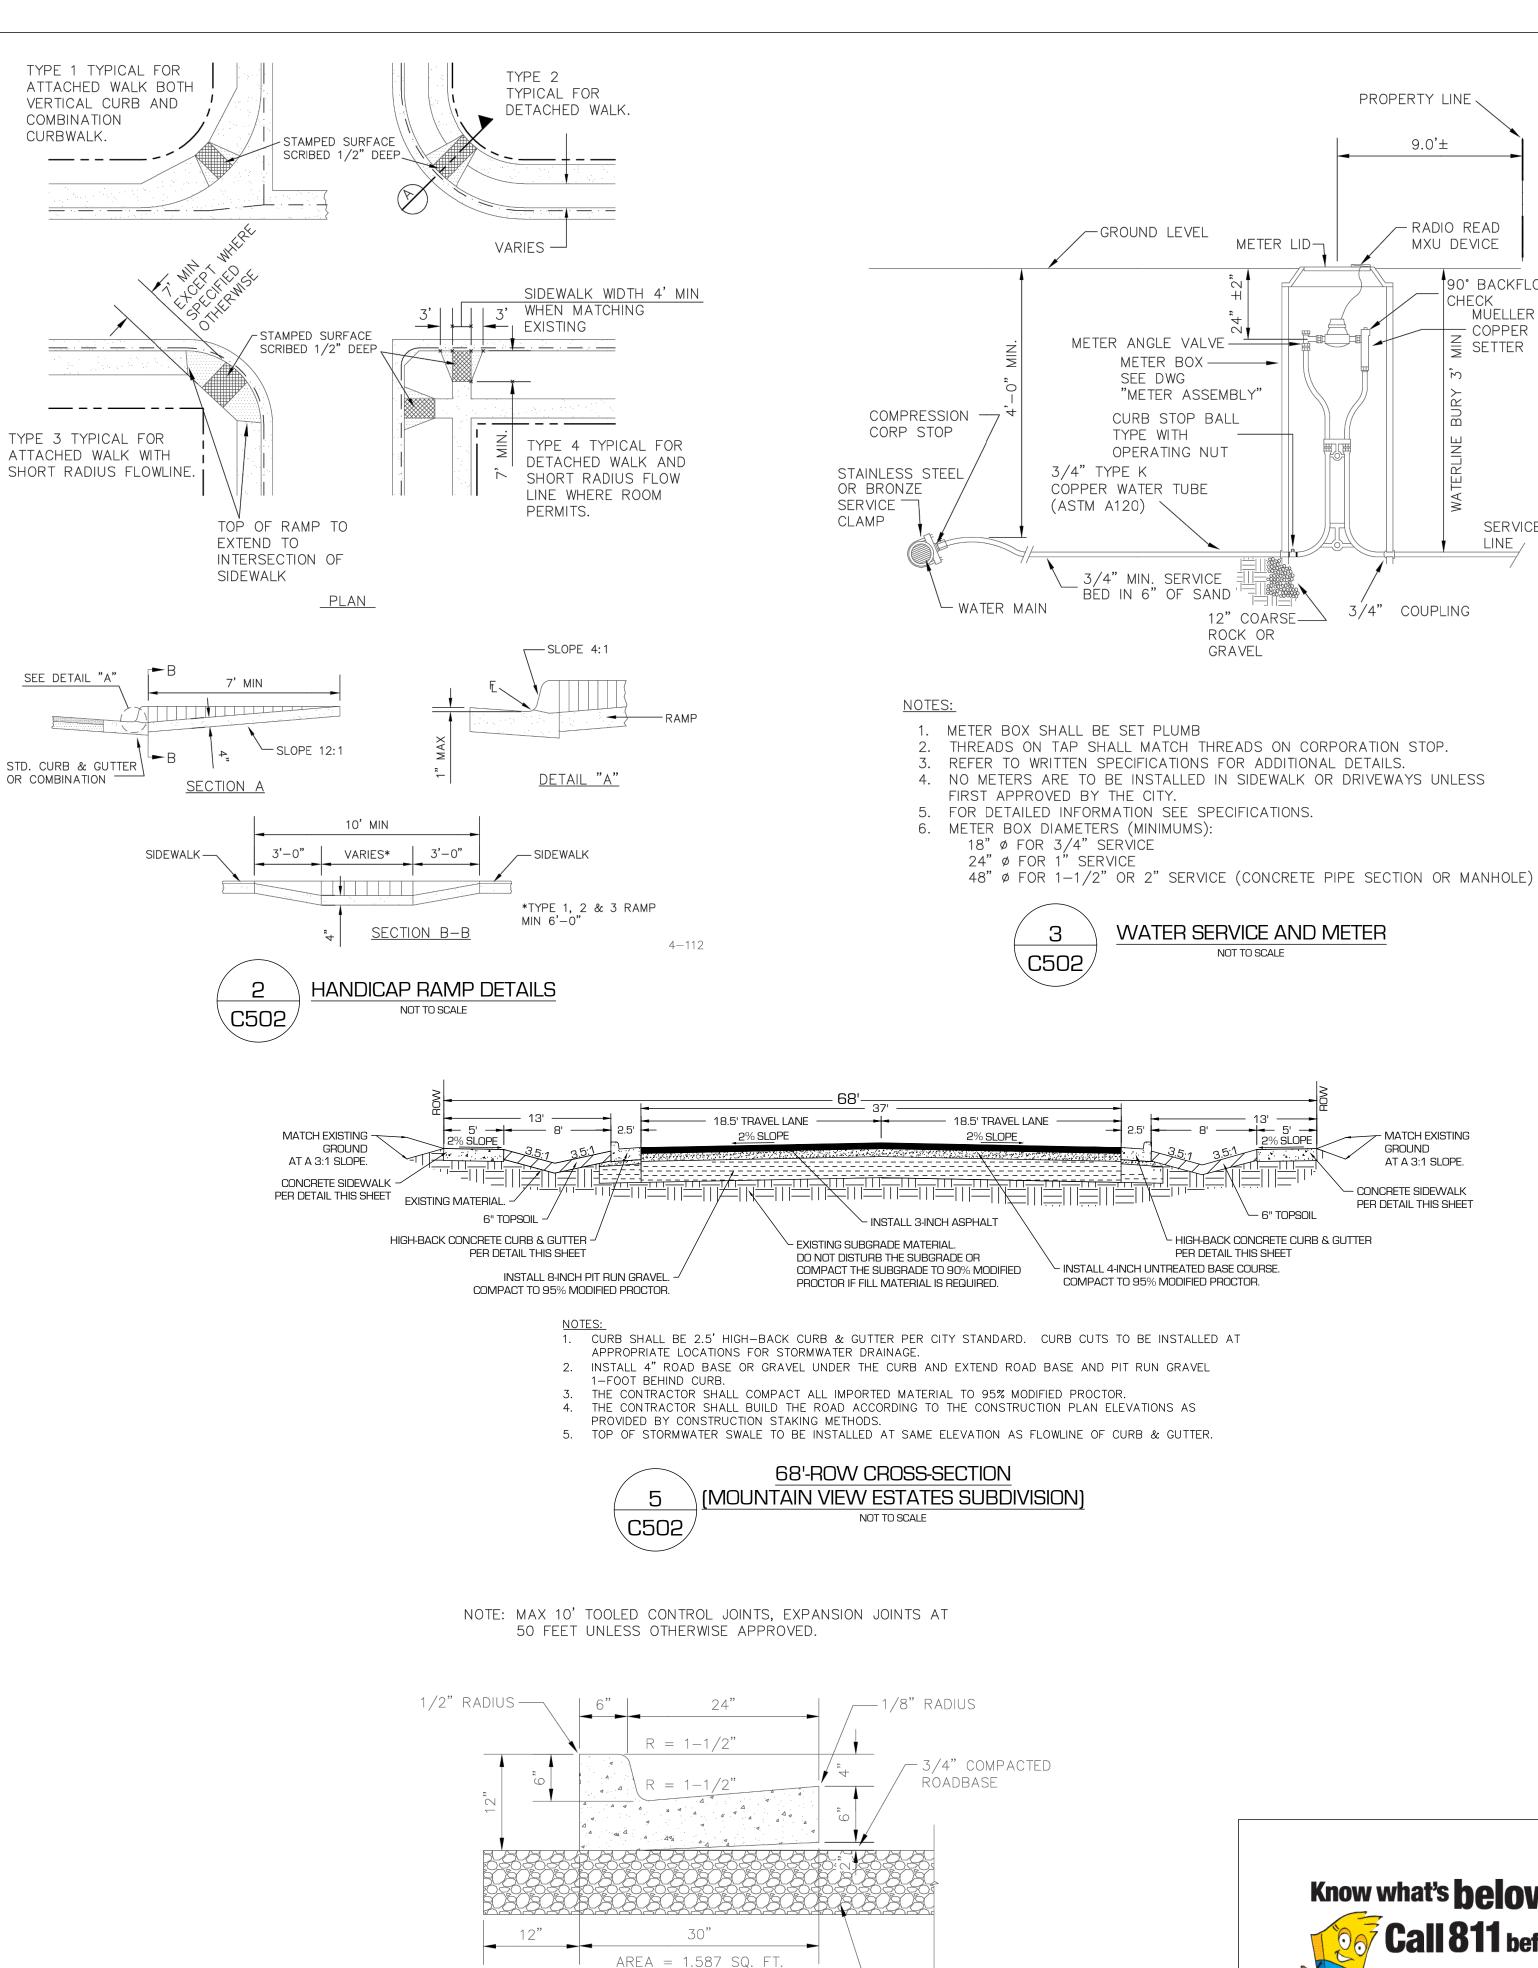

HIGH-BACK CURB AND GUTTER

ALL CURB & GUTTER IS TO BE BEDDED WITH UNTREATED BASE COURSE

30" CURB AND GUTTER DETAIL

NO HONEYCOMB WILL BE PERMITTED

NO GRAVEL SHALL BE PERMITTED

-8" MINIMUM PIT RUN

BORROW



THESE PLANS AND SPECIFICATIONS ARE THE PROPERTY OF CIVIL SOLUTIONS GROUP, INC, AN SHALL NOT BE PHOTOCOPIED, RE-DRAWN, OR USED ON ANY OTHER PROJECT OTHER THAN THE PROJECT SPECIFICALLY DESIGNED FOR, WITHOUT WRITTEN PERMISSION. THE OWNERS AND ENGINEERS OF CIVIL SOLUTIONS GROUP, INC. DISCLAIM ANY LIABILITY FOR ANY CHANGES OR MODIFICATIONS MADE TO THESE PLANS OR THE DESIGN THEREON WITHOUT THEIR CONSENT. THESE PLANS ARE DRAWN TO SCALE WHEN PLOTTED ON A 24" X 36" SHEET OF

S 4

PROPERTY LINE

3/4" COUPLING

- CONCRETE SIDEWALK PER DETAIL THIS SHEET

- HIGH-BACK CONCRETE CURB & GUTTER

PER DETAIL THIS SHEET

ROCK OR

GRAVEL

9.0'±


-RADIO READ MXU DEVICE

90° BACKFLOW

CHECK MUELLER

COPPER

SETTER

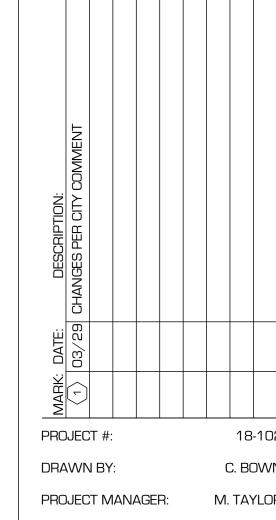

C. BOWN M. TAYLOR M. TALYOR DESIGNED BY:

ISSUED: 03.29.18



STANDARD **DETAILS**

Mountain View Estates Phase 2

	Concept Estimate										
	Civil Solutions Group, Inc.										
	540 W Golf Course Road, Suite B1, Providence, UT 84332				Telephone 435-213-3762						
	Providence, UT 84332			mtaylor@civ	ilsolutionsgroup.net						
	Date: March 19, 2018										
	Description	Quantity	Unit	Amount	Total Amount						
	General Transition of the Control of		1	00.500.00	00 500 00						
1	Mobilization and Site Clean-up	1	LS	\$2,500.00 \$900.00	\$2,500.00 \$900.00						
2	Installation and Maintenance of Rock Tracking Pad	69,174	LS	\$900.00	\$6,917.40						
3	Clear and Grub										
4 5	Install 6" On-Site Topsoil	312 1,634	CY	\$16.00 \$7.50	\$4,993.19 \$12,257.78						
6	12" Import Granular Borrow Fill under asphalt & Curb (1-ft beyond curb) 4" Untreated Road Base Fill under asphalt and curb (1-ft beyond curb)	44,128	SF	\$0.35	\$12,257.78 \$15,444.80						
7	3" Asphalt	35,746	SF	\$1.15	\$15,444.80 \$41,107.90						
8	4" Thick Concrete Sidewalk w/ 4" Gravel	10,614		\$3.00	\$31,842.00						
9	ADA Ramps	10,014	EA	\$250.00	\$1,000.00						
10	30" Concrete Curb and Gutter w/ 4" Gravel Base	2,203	LF	\$250.00 \$11.00	\$1,000.00						
10	50 Concrete Curb and Gutter W/ 4 Gravet base	2,203	LF	\$11.00	\$24,233.00						
	SUBTOTAL C	GENERAL			\$141,196.06						
4	Water Line	2	T7 A	¢1 000 00	62 000 00						
1	Connect to Existing Water System	3	EA	\$1,000.00	\$3,000.00						
2	8" AWWA C900 DR14 Water Line (Includes all tees, valves, bedding, trenching, backfill, thrust blocking, etc)	850	LF LF	\$30.00	\$25,500.00						
3 4	10" AWWA C900 DR14 Water Line (Includes all tees, valves, bedding, trenching, backfill, thrust blocking, etc)	597 2		\$35.00	\$20,895.00						
4	Fire Hydrant and Assembly (includes 6" valve and tee) 6" AWWA C900 DR14 Water Line to Hydrants (Includes all tees, valves, bedding, trenching, backfill, thrust blocking,		EA	\$4,500.00	\$9,000.00						
5	, , , , , , , , , , , , , , , , , , , ,	20	LF	624.00	£400.00						
6	etc) 1" Water Service	16		\$24.00 \$1,700.00	\$480.00 \$27,200.00						
О	1 Water Service SUBTOTAL WAT		EΛ	\$1,700.00	\$86,075.00						
	SUBIOTAL WAS	LEK LINE			φου,075.00						
	Sewer Line										
1	Connect to Existing Sewer Manhole	2	EA	\$1,000.00	\$2,000.00						
2	10" PVC Sewer Line (Includes all bedding, trenching, backfill, etc.)	300	LF	\$45.00	\$13,500.00						
3	8" PVC Sewer Line(Includes all bedding, trenching, backfill, etc.)	302	LF	\$39.50	\$11,929.00						
4	4" Sewer Service	16	EA	\$1,000.00	\$16,000.00						
	AVIDMONUV ADVI				*12.120.00						
	SUBTOTAL SEWER LINE \$43,429.00										
	Irrigation Line										
1	6" PVC (160 psi) Irrigation Pipe (Includes all valves, bedding, backfill, tees, bends, thrust blocking, etc)	407	LF	\$24.00	\$9,768.00						
2	1" PVC Poly Irrigation Service	16	EA	\$800.00	\$12,800.00						
3	Connect to Existing Irrigation System	2	EA	\$1,000.00	\$2,000.00						
	SUBTOTAL IRRIGATION LINE \$24,568.00										
	Utility Work										
	ouny work										
1	Power Conduit, Trenching (for Power, Cable, Phone), Bedding, & Backfill (estimated length)	2,260	LF	\$4.00	\$9,040.00						
2	4" Schedule 40 Conduit w/Labor (estimated length)	2,260	LF	\$2.35	\$5,311.00						
	SUBTOTAL UTILITY WORK \$14,351.00										
	SUBTOTAL UTILI	TY WORK			\$14,351.00						
	Miscellaneous										
1	Materials Testing (Per Contractor)	1	LS	\$2,000.00	\$2,000.00						
	SUBTOTAL MISCELLANEOUS \$2,000.00										
	SUBTOTAL MISCELLANEOUS \$2,000.00										
	SUBTOTAL										
	CONTINGE				\$15,580.95						
		D TOTAL			\$327,200.02						
	Croated by M. Taylor										

Created by: M. Taylor

Mountain View Estates Phase 2

Concept Estimate

Civil Solutions Group, Inc. 540 W Golf Course Road, Suite B1, Providence, UT 84332

Providence, UT 84332

mtaylor@civilsolutionsgroup.net Date: March 19, 2018

Description Total Amount Quantity Unit Amount

Telephone 435-213-3762